Building Permits & Inspections is now doing Drywall nail inspections and Insulation inspections. Inspection code 114 for Insulation. Inspection code 111 for Drywall nail. Please schedule hese inspections prior to installing drywall or finishing drywall.



THUY NGUYEN'S RESIDENCE

6324 STACY AVE, SACRAMENTO CA, 95823

PLANS APPROVED FOR PERMIT he local Fire Authority where this project is located Tony Nguyen

VICINITY MAP

Assessor Parcel Viewer

LOW - RISE - MANDATORY- MEASURES- SUMMARY

FASTENING SCHEDULE PER CRC TABLE R602.3 (1)

NOTES

a) Please note that a Building Permit cannot be issued

until all clearances by all reviewing departments (listed

above) have been approved on the project. Check the

contact the individual departments directly with any

delta number with a revision mark at each location

comments may be triggered once revised plan are

c)When comments cite a section of code and require

a revision, correction or amendment to plans, required information shall be specifically & directly provided on

plans. Generic references to code section(s) is not

status of your permit by visiting www.sjpermits.org and

b) Revised plans, when required, must be clouded with

where revision has occurred and be noted that additional

STRUCTURAL GENERAL NOTES


- DESIGNATE ONE AREA OF THE CONSTRUCTION SITE FOR THE STAGING OF VEHICLES. MATERIAL DELIVERIES, AUTOS AND EQUIPMENT, CONSTRUCTION RELATED ITEMS STORED ON-SITE SHALL BE CONFINED TO THIS AREA. REFUELING AND ROUTINE VEHICLE AND EQUIPMENT MAINTENANCE SHALL BE PERFORMED IN THE DESIGNATED AREA. THE DESIGNATED AREA SHALL BE WELL AWAY FROM STREAMS OR OTHER SURFACE STORM DRAINAGE SYSTEMS, SO AS TO AVOID POTENTIAL CONTAMINATION OF THE RUN-OFF. THE LOCATION SHALL BE COORDINATED WITH THE BUILDING
- EQUIPMENT UTILIZED ON THE PROJECT SHALL BE WELL MAINTAINED AND IN GOOD WORKING ORDER. INSPECT ALL EQUIPMENT REGULARLY, WITH ANY MAJOR REPAIRS NECESSITATED PERFORMED OFF-SITE. EQUIPMENT SHALL NOT REMAIN STORED ON-SITE FOR PERIODS LONGER THAN THAT NEEDED FOR THE INTENDED FUNCTION, BASED UPON THE WORK BEING PERFORMED. WASHING OF EQUIPMENT SHALL NOT BE PERFORMED ON-SITE
- MAINTAIN A DUMPSITE FOR CONSTRUCTION DEBRIS. PLACE DUMPSTER UNDER A ROOF OR COVERED BY TARP SECURED AROUND THE OUTSIDE OF THE DUMPSTER. DO NOT CLEAN OUT A DUMPSTER BY HOSING DOWN ONTO THE CONSTRUCTION SITE.
- MAINTAIN PORTABLE TOILETS ON-SITE FOR THE USE OF THE CONSTRUCTION PERSONNEL. CHECK FOR LEAKS TO ENSURE THAT THEY ARE IN GOOD WORKING ORDER.
- SCHEDULE EXCAVATION AND GRADING ACTIVITIES FOR DRY WEATHER PERIODS. COVER EXPOSED PILES OF SOIL OR STOCKPILES OF CONSTRUCTION MATERIALS WITH PLASTIC SHEETING OR TEMPORARY ROOFS AND PROTECT FROM WIND. SWEEP OR CLEAN DUST AND DEBRIS ACCUMULATED ON PAVING OR SIMILAR SURFACES THAT DRAIN INTO STORM WATER SYSTEMS PRIOR TO THE ONSET OF INCLEMENT WEATHER. DO NOT HOSE-DOWN SUCH SURFACES WHERE MATERIALS HAVE SPILLED.
- AVOID CREATING EXCESSIVE AMOUNTS OF DUST WHEN BREAKING AND REMOVING ASPHALT OR CONCRETE PAVING. SHOVEL OR VACUUM SAW-CUT SLURRY AND REMOVE FROM SITE. COVER OR BARRICADE STORM DRAIN INLETS DURING SAW-CUTTING AS NECESSARY. DO NOT HOSE-DOWN STREETS TO CLEAN UP DEBRIS.
- AVOID PAVING AND SEAL COATING IN WET WEATHER, OR IF RAIN IS IMMINENT BEFORE FRESH PAVEMENT WILL HAVE TIME TO CURE. COVER AND SEAL CATCH BASINS AND MANHOLES WHEN
- 8. WHEN CLEANING UP AFTER CONCRETE PAVING WORK, WASH FINES AND EXCESS MATERIALS INTO DIRT AREAS. WASH OUT CONCRETE MIXERS ONLY IN DESIGNATED AREAS WHERE WATER WILL FLOW INTO CONTAINMENT PONDS OR ONTO DIRT AREAS. DISPOSAL OF WASHOUT INTO THE STREET OR STORM DRAINAGE SYSTEM IS PROHIBITED BY LAW.
- MAKE EVERY EFFORT TO RECYCLE WASTE PRODUCTS WHERE POSSIBLE. TYPICALLY, SOLVENTS, WATER BASED PAINTS, VEHICLE FLUIDS, BROKEN ASPHALT AND CONCRETE, WOOD AND CLEARED VEGETATION CAN BE RECYCLED. THOSE MATERIALS WHICH ARE NOT RECYCLABLE SHALL BE DISPOSED OF AT AN APPROPRIATE LANDFILL SITE OR TREATED AS HAZARDOUS WASTE AS REQUIRED. IN NO CASE SHALL WASTE PRODUCTS BE BURIED ON-SITE
- KEEP POLLUTANTS OFF OF EXPOSED SURFACES. CLEANUP SPILLED MATERIALS IMMEDIATELY CLEAN UP SPILLS ON DIRT AREAS BY REMOVING AND PROPERLY DISPOSING OF CONTAMINATED SOIL. SURFACES WHERE MATERIALS HAVE BEEN SPILLED SHALL NOT BE HOSED-DOWN, USE DRY CLEANUP METHODS WHENEVER POSSIBLE. WHERE WATER MUST BE USED, USE IT SPARINGLY. SIGNIFICANT HAZARDOUS SPILLS SHALL BE REPORTED TO THE APPROPRIATE SPILL AGENCY IMMEDIATELY AND/OR DIAL 911 AS NECESSARY
- 11. CONSTRUCTION SITE SHALL COMPLY WITH APPLICABLE PROVISIONS OF THE CFC CHAPTER 33 AND COUNTY STANDARD DETAIL AND SPECIFICATION SI-7
- 12. ALL CONSTRUCTION MATERIALS AND WORKMANSHIP SHALL CONFORM TO THE COUNTY OF SACRAMENTO STANDARD SPECIFICATION, DATED JUNE 2007.
- 12.1. THE CONTRACTOR IS RESPONSIBLE FOR DETERMINING THE EXACT LOCATION OF ALL EXISTING UTILITIES AND FOR THE PROTECTION OF AND REPAIR OF DAMAGE TO THEM. CONTACT UNDERGROUND SERVICE ALERT 1-800-642-2444, 48 HOURS BEFORE WORK IS TO
- THE CONTRACTOR SHALL PROVIDE EROSION, SEDIMENT, AND POLLUTION CONTROL BEST MANAGEMENT PRACTICES (BMPS) WHEN AND WHERE APPLICABLE PER THE COUNTY OF SACRAMENTO STANDARD SPECIFICATIONS SECTION 16-3.
- 12.3. DIRECT ALL NEW DOWNSPOUTS ONTO NATURAL GROUND OR LANDSCAPED AREAS WHERE FEASIBLE
- 12.4. FLOOD ZONE X PANEL 0302
- 12.5. NO PERMANENT STRUCTURE (INCLUDING WITHOUT LIMITATION GARAGES, PATIOS, CONCRETE SLABS, TOOL SHED, ROOF OVERHANGS AND SIMILAR STRUCTURES) SHALL BE CONSTRUCTED ON TOP OF WATER, SEWER OR DRAINAGE PIPELINES OR ANYWHERE WITHIN THE ASSOCIATED UTILITY EASEMENTS. (ORD. 2001-033)
- CONTRACTOR IS RESPONSIBLE FOR DETERMINING EXACT LOCATIONS AND PROTECTION OF ALL EXISTING MAINS AND LINES. YOU CAN CONTACT\COUNTY\CREWS AT 311 TO LOCATE SERVICES. IT IS THE RESPONSIBILITY OF THE PROPERTY OWNER TO DETERMINE THE LOCATION OF ANY EASEMENTS OF RECORD ENCUMBERED WITHIN THE PROPERTY


Smoke and Carbon Monoxide Alarms are required

to be installed and operational at Final Inspection.

verify location and operation before permit is final

The Building Inspector will need to have access to

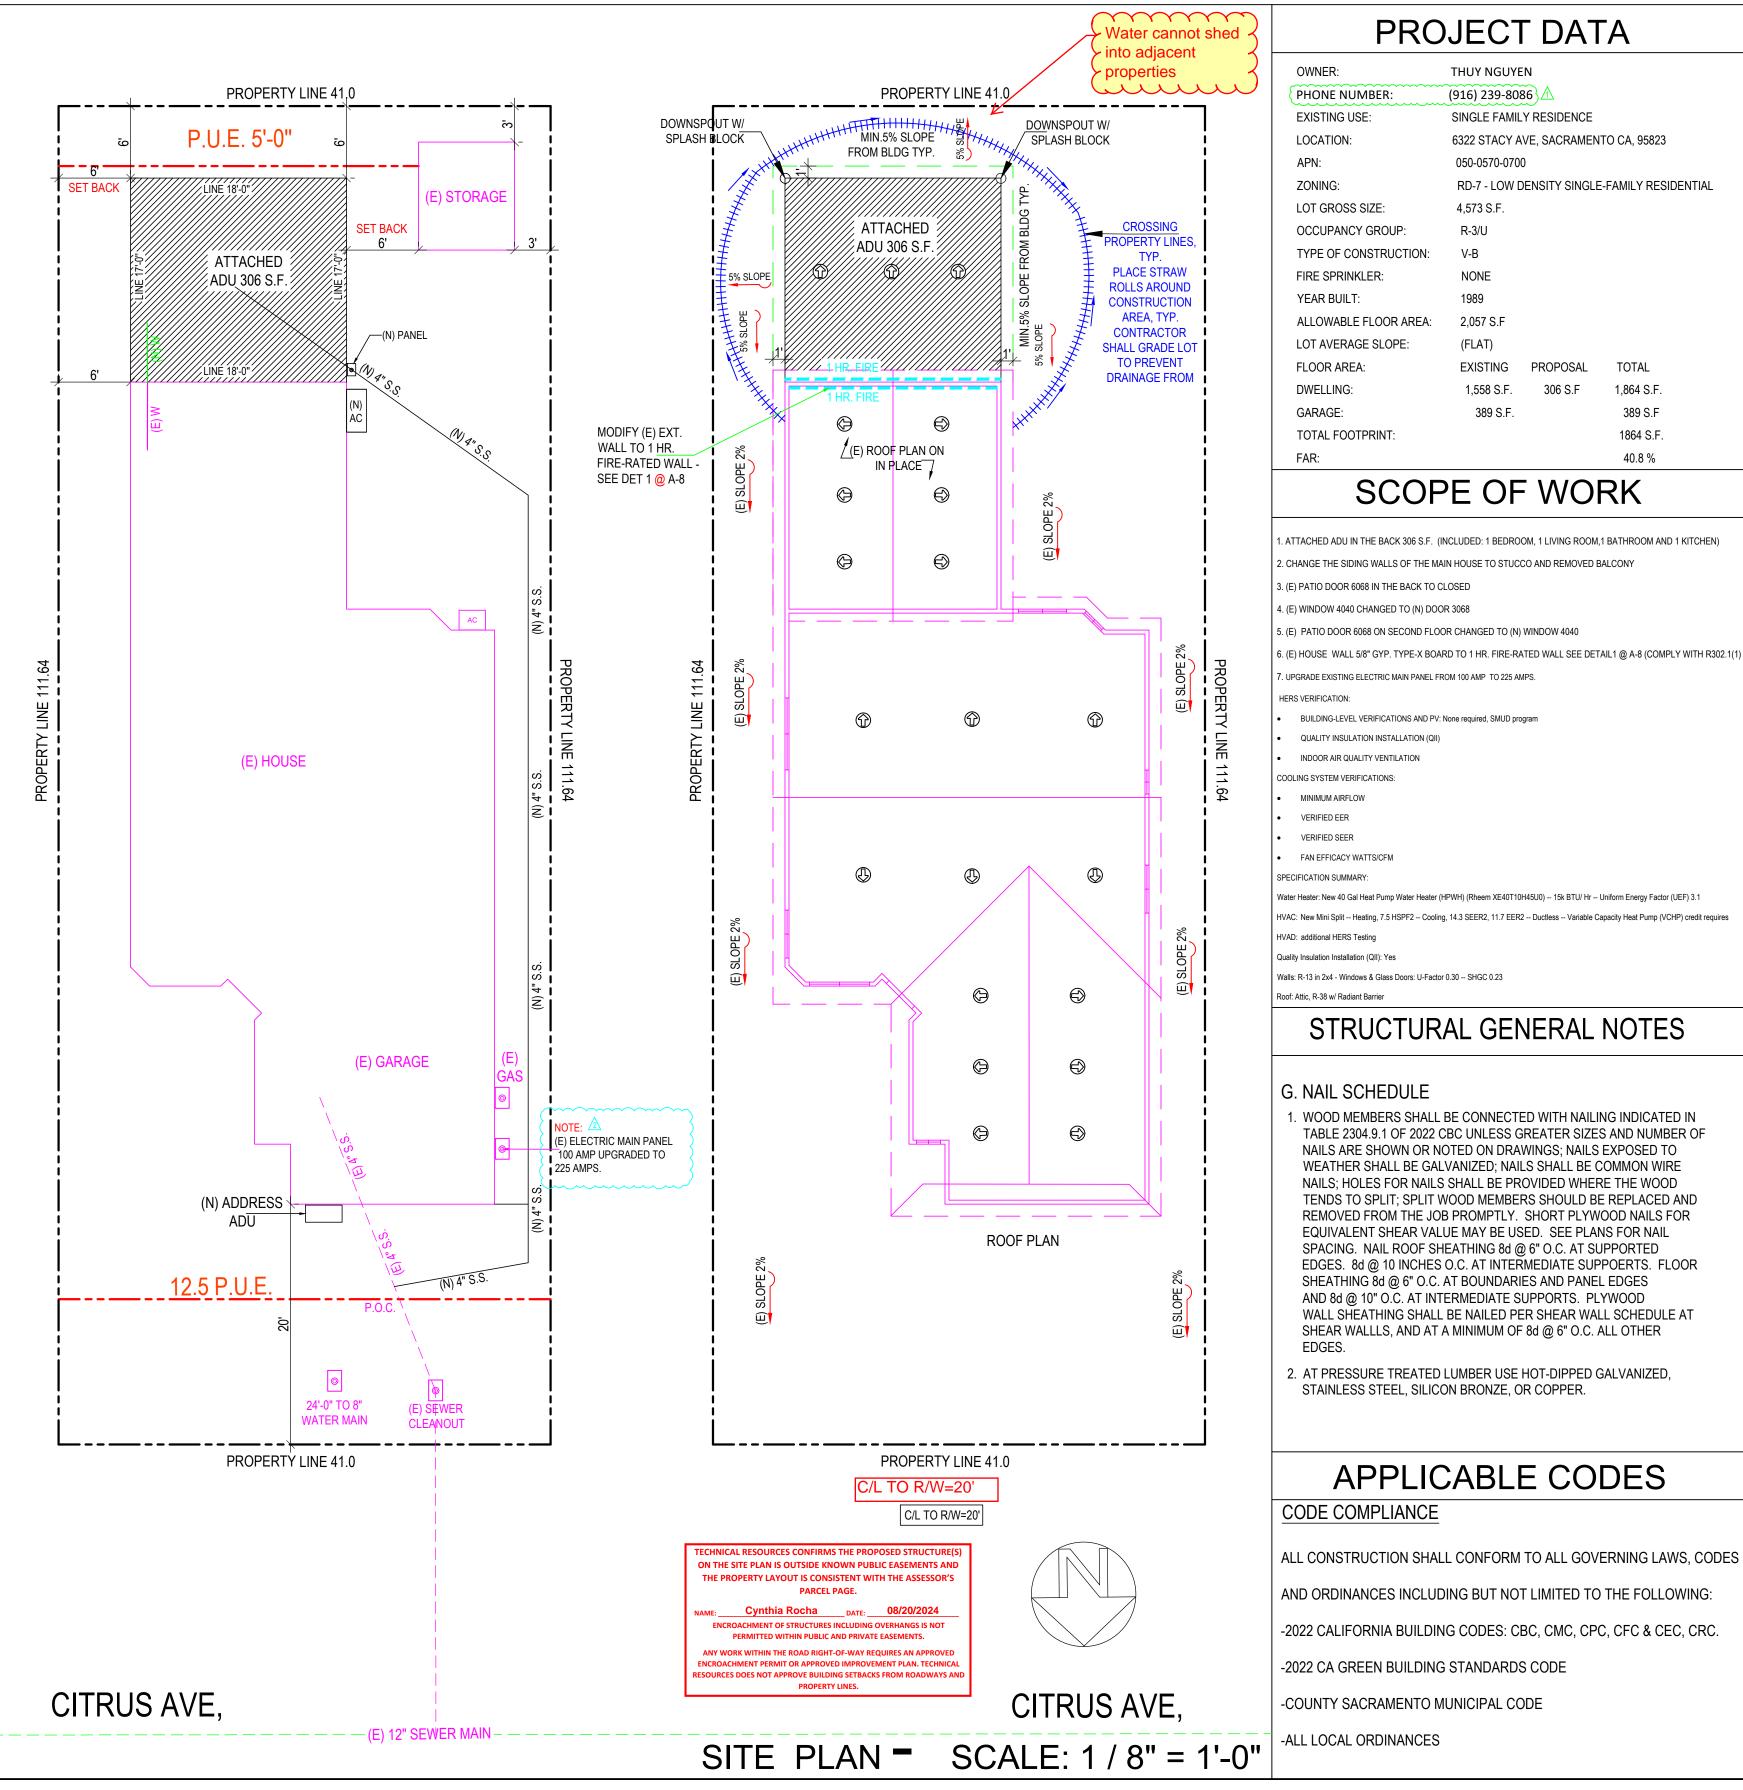

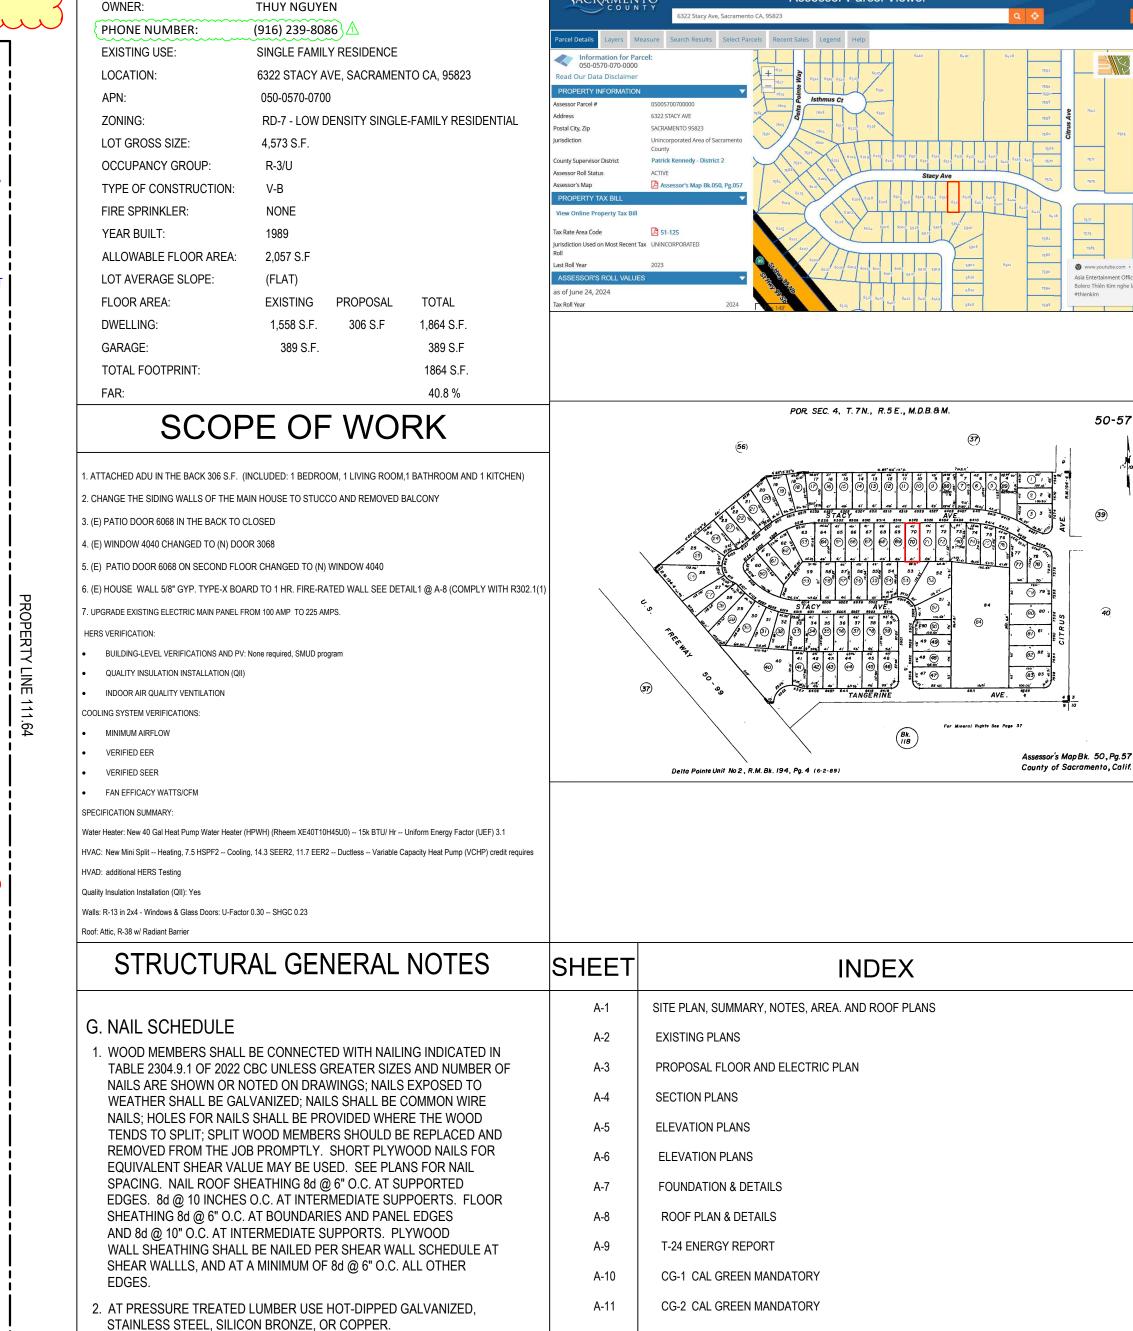

PROJECT DATA

APPLICABLE CODES



Scale: AS SHOWN Drawn: LUYEN HONG NGUYEN STAMPED FROM CITY



PLAN REVIEW APPROVAL


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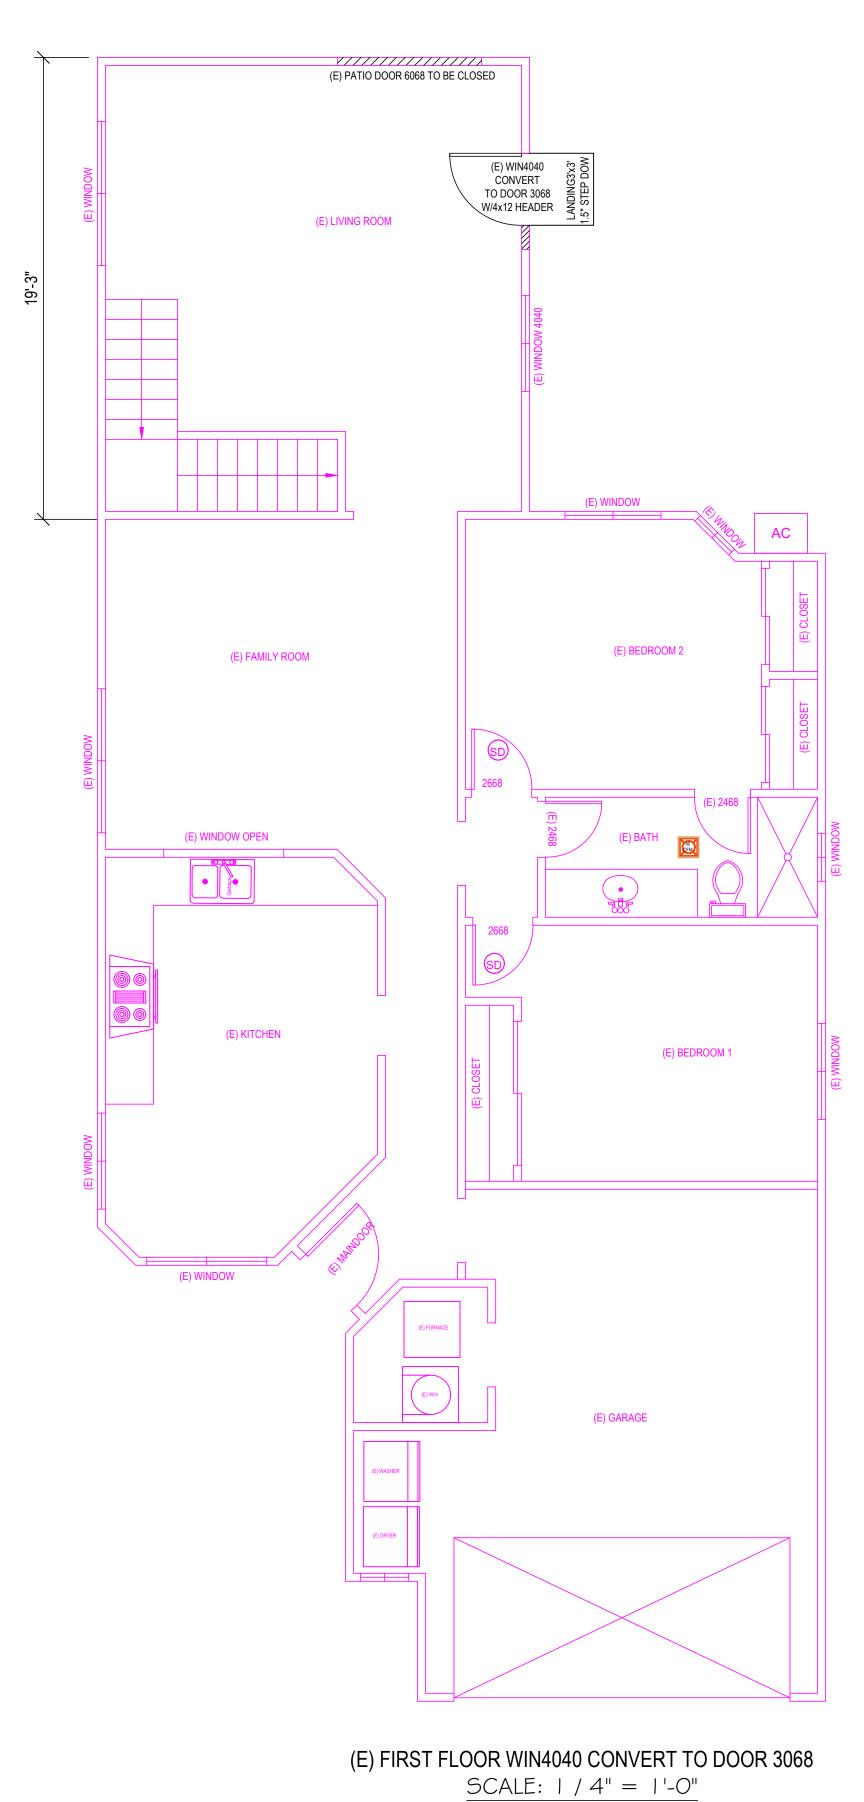
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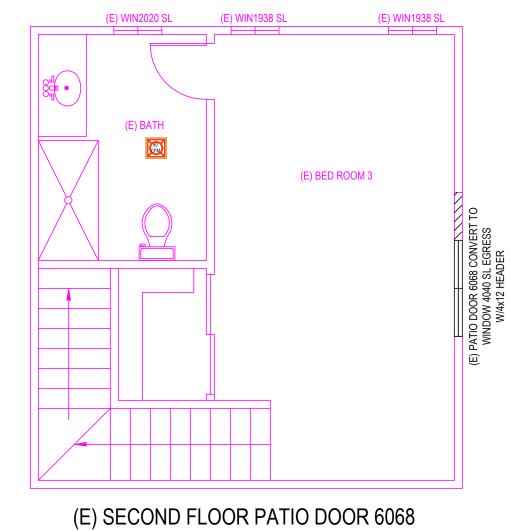
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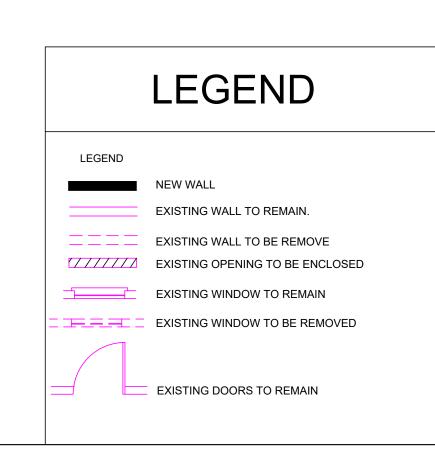




(E) SECOND FLOOR PATIO DOOR 6068

CONVERT TO WINDOW 4040 SL EGRESS

SCALE: | / 4" = | '-O"

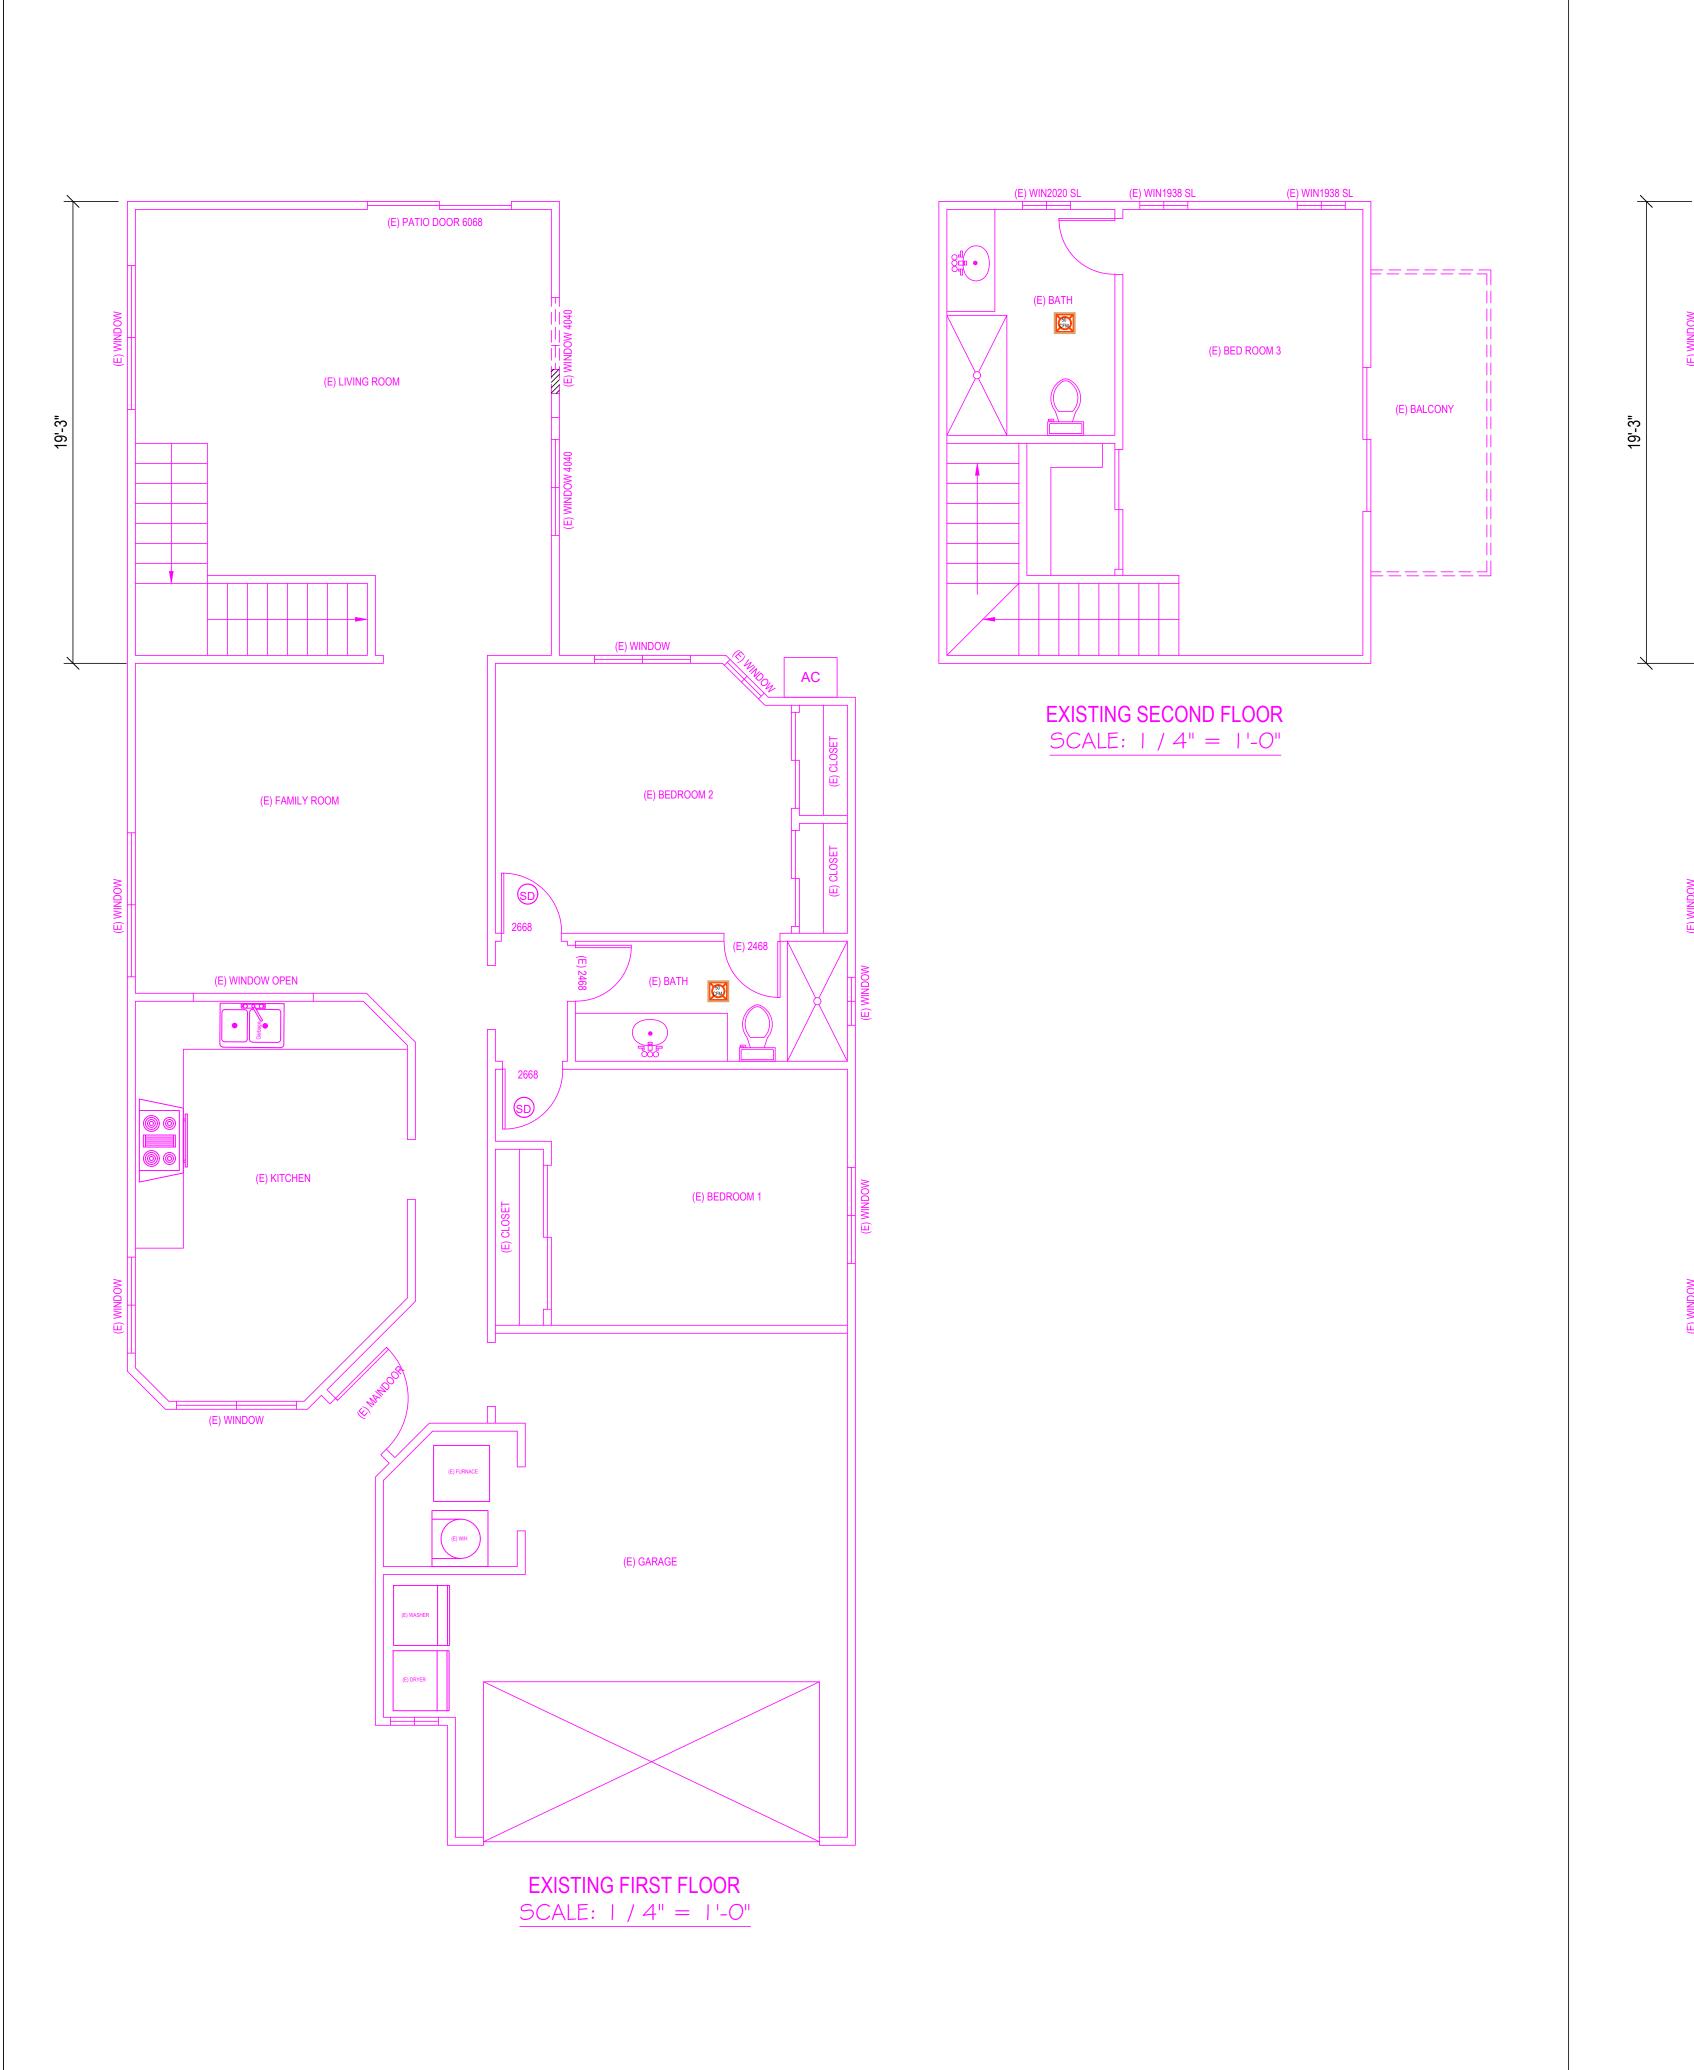



Date: AUGUST 2024

Scale: AS SHOWN

Drawn: LUYEN HONG NGUYEN

Signed: Thuy

STAMPED FROM CITY

JOB **10/07/2024**

EXISTING PLAN

HUY NGUYEN'S RESIDENCE
6322 STACY AVE,

SACRAMENTO CA, 95823

REVISION DATE BY

SHEET NO:

A-2

FLOOR PLAN NOTES:

FLOOR PLAN NOTES:

1. ALL CONCRETE TO BE POURED ON UNDISTURBED SOIL 2. ALL LUMBER IN CONTACT WITH CONCRETE SHALL BE FOUNDATION GRADE RWD OR PRESSURE TREATED.

3. ALL LUMBER USED IN CONSTRUCTION LOCATED NEARER THAN 8" TO EARTH SHALL BE F.G. RWD OR P.T.

4. PROVIDE SOLID BLOCKING FOR ALL PONY WALLS LESS THAN 14" HIGH

5. PROVIDE FIRE STOPS@CONCEALED DRAFT OPENING, CEILING LINES, FLOOR LINES, FURRED AREAS. SUSPENDED CEILINGS, STAIR STRINGERS, SHOWERS, CHIMNEY ENCLOSURES, & MID HEIGHT OF WALLS OVER 10" IN HEIGHT.

6. VERIFY MIN. 22"x30" FLOOR ACCESS. ATTIC ACCESS WITH 30" CLEARING ABOVE OPENING

7. DOORS, WINDOWS, & SHOWER DOORS WITHIN HAZARDOUS AREAS TO BE

TEMPERED. 8. ALL POSTS, BEAMS & WALLS SUPPORTING THE FLOOR CEILING SHALL HAVE ONE-HOUR FIRE PROTECTION

9. ALL NEW WINDOWS AND GLASS SLIDING DOOR SHALL BE LOW-E DUAL GLAZED U.N

10. MATERIAL GRADE STAMPS WILL BE CHECKED ON FRAME INSPECTION

11 ALL CONSTRUCTION SHALL COMPLY WITH THE 2022 EDITION OF THE CBC, CMC, CPC, CEC, CRC

AND CFC AND THE 2022 CALIFORNIA ENERGY CODE

1.) CABINET CHANGES WHEN NOT BEING SUPPORTED ENTIRELY BY THE ROOF STRUCTURE,

12 CHANGES FROM THE AP PROVED PLANS DURING CONSTRUCTION OTHER THAN

APPROVED PLAN.

2) INTERIOR NON-STRUCTURAL WALL FINISHES SHALL CAUSE PLAN APPROVAL AND CONSTRUCTION

TO BE SUSPENDED A NEW PLAN CHECK (FOR A NEW PLAN) SHOWING CHANGES WILL BE SUBMITTED FOR REVIEW AND APPROVAL THROUGH THE NORMAL PLAN CHECK PROCESS.

13. FIRE BLOCKING WITH NON-COMBUSTIBLE MATERIAL SHALL BE PROVIDED IN. **OPENINGS**

AROUND VENTS, PIPES, DUCTS, FIREPLACES, AND SIMILAR OPENINGS. PER CBC 708.2.1 (4).

14. PROVIDE SMOKE DETECTORS (HARDWIRED 110v W/BAT BACK-UP) IN EVERY BEDROOMS, THE HALL

WAY TO THE BEDROOM, PROVIDE CARBON MONOXIDE SMOKE, ALARM DETECTOR IN ALL SLEEPING ROOM.

15. IN EACH NEW BEDROOM, THERE IS AT LEAST ONE WINDOW, FOR. EMERGENCY ESCAPE OR RESCUE: REQUIRE OPENING OF MINIMUM NET. CLEAR AREA, 5.7 SQ. FT. HEIGHT 24", WIDTH 20", AND MAXIMUM FINISHED. OPENING HEIGHT 44"ABOVE FINNISH FLOOR.

16. NEW 3'X3' MIN, CONCRETE LANDING AT ALL NEW EXTERIOR DOOR. LANDING. SHALL NOT BE LOWER THAN 7-1/2" FROM FLOOR LEVEL.

17. BATHROOM SLIDING DOOR MUST BE TEMPERED GLASS

18. ALL NEW BEDROOM MUST BE AFCI CIRCUIT.

19. PRESSURE OR THERMOSTATIC MIXING VALVE AT THE SHOWERS AND TUBS, WHICH LIMIT WATER TEMPERATURE TO 120 DEGREES F

20. THE SHOWERS MUST HAVE INSIDE DIMENSION OF AT LEAST 30 INCHES, THE

TOTAL FLOOR AREA

OF A SHOWER MUST BE AT LIST 1,024 SQUARE INCHES, OPENING TO SHOWER MUST BE MIN.

24 INCHES WIDE, THE DOOR MUST BE TEMPERED GLASS.(SEE DETAILS)

ELECTRICAL NOTES:

MOTION SENSOR WITH INTEGRAL PHOTO CONTROL

2. ALL HARDWIRED LIGHTING IN BATHROOMS, GARAGES, LAUNDRY AND UTILITY ROOMS MUST BE HIGH EFFICACY OR CONTROLLED BY A MANUAL-ON MOTION

3. ALL HARDWIRED LIGHTING IN OTHER ROOMS (HALLWAYS, DINING ROOMS, FAMILY ROOMS AND BEDROOMS) SHALL BE HIGH EFFICACY OR CONTROLLED BY A MANUAL-ON OCCUPANT SENSOR OR A DIMMER MUST CONTROL IT. 4. ALL SWITCHES ON A MULTIPLE SWITCHED CIRCUIT SHALL BE CONTROLLED BY THE DIMMER SWITCH ON THAT CIRCUIT.

5. ALL RECESSED FIXTURES SHALL BE LABELED AS BEING CERTIFIED TO HAVE A LEAKAGE RATING OF LESS THAN 2.0 AT 75 PASCAL.

6. ALL HIGH EFFICACY FIXTURES AND NON-HIGH EFFICACY FIXTURES SHALL BE

SWITCHED SEPARATELY. 7. SMOKE DETECTOR SYSTEM SHALL BE HARD-WIRED, INTERCONNECTED TO. 8. MIN. 50% OF WATTAGE OF LIGHTS IN KITCHEN SHALL BE HIGH EFFICACY

AND THOSE THAT ARE NOT SHALL BE SWITCHED SEPARATELY. 9. LIGHTS MOUNTED TO EXTERIOR OF BUILDING SHALL BE HIGH EFFICACY OR ON A PHOTO CONTROL/MOTION SENSOR COMBINATION.


LAMP POWER RATING:	MINIMUM LAMP EFFICACY:
15 watts or less	40 lumens per watt
over 15 watts to 40 watts	50 lumens per watt
over 40 watts	60 lumens per watt

NOTES:

WATER-RESISTANT GYPSUM BACKING BOARD SHALL NOT BE USED WHERE THERE WILL BE DIRECT EXPOSURE TO WATER. OR IN AREAS SUBJECT TO CONTINUOUS HIGH HUMINITY . R702.3.7.1


on plan the fire-resistance-rated floor/ceiling and wall assemblies shall extend to and be tight against the exterior wall, and wall assemblies shall extend from the foundation to the underside of the roof sheathing or rated floor/ceiling


NOTE: 🔼 All 120-volt, single-phase, 15- and 20-ampere branch circuits supplying outlets or devices installed in all living spaces, including kitchen shall be protected by AFCI (Arc-fault circuit interrupter) and tamper resistant . CEC 210.12.

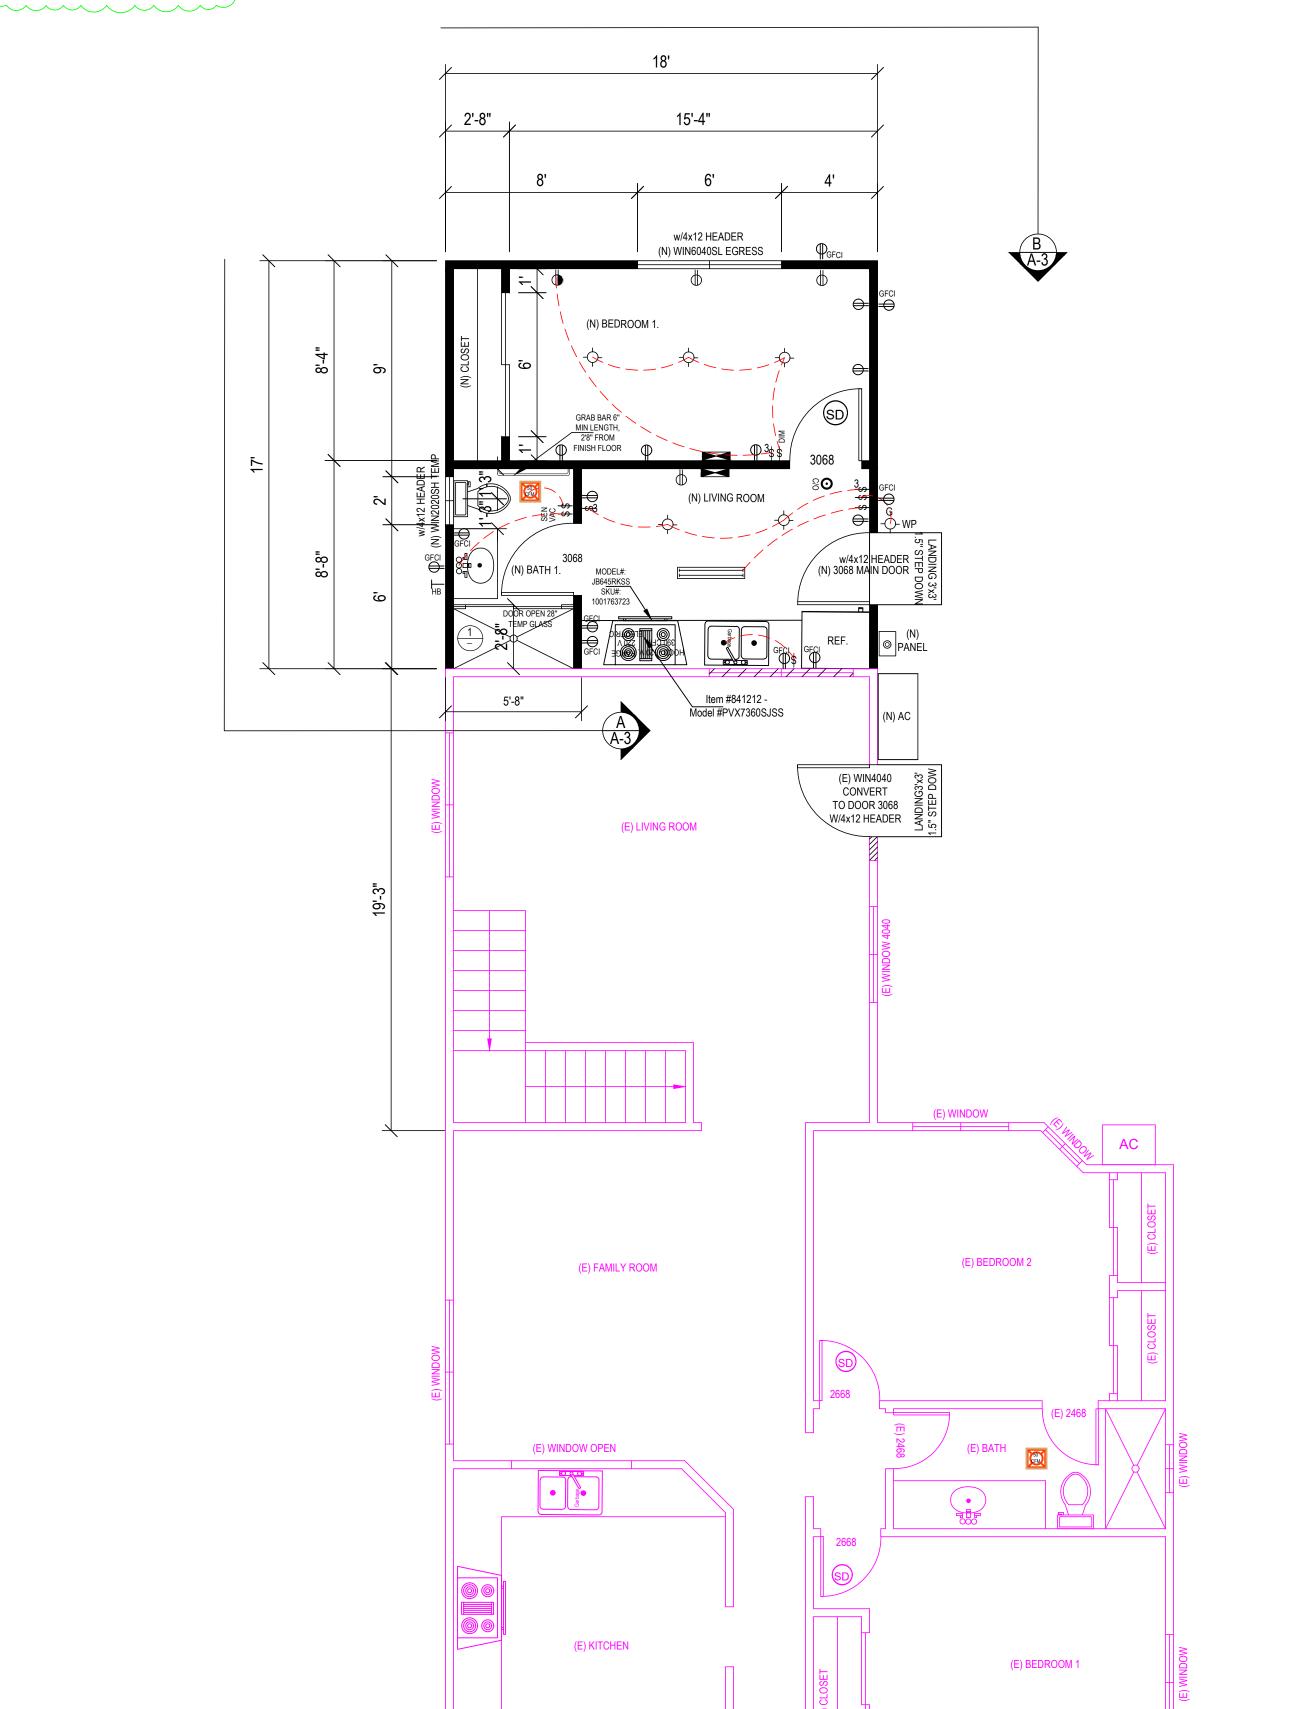


ADU PROPOSAL FIRST FLOOR PLAN

SCALE: 1/4" = 1'-0"

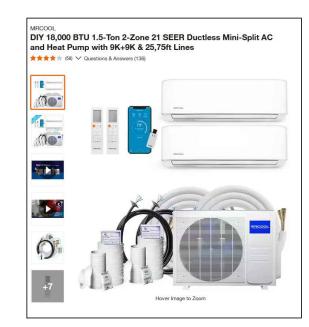

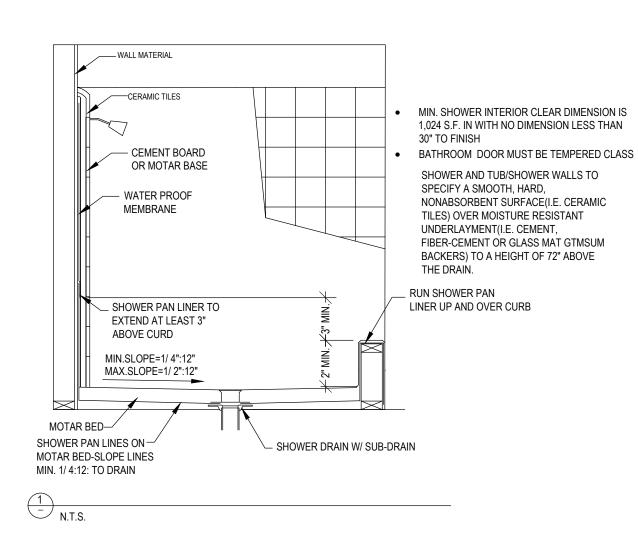

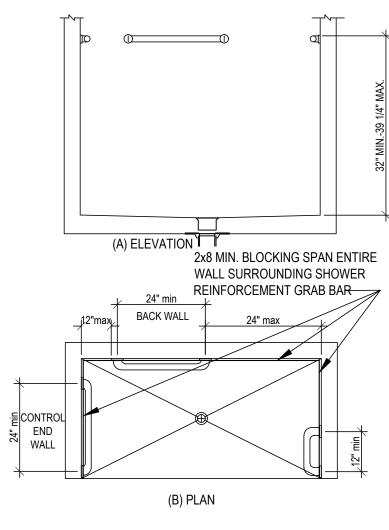

GRAB BAR REINFORCEMENT ON ALL SHOWER WALLS Aging-In Design note added For reinforcement a) Reinforcement shall not be less than 2x8 nominal lumber or other construction material providing equal height and load capacity. Reinforcement shall be located between 32 inches and 39-1/4 inches above the finish floor flush with the wall framing. b) Water closet reinforcement shall be installed on both side walls of the fixture, or one side wall and the back c) Shower reinforcement shall be continuous where wall framing is provided. d) Bathtub and combination bathtub/shower reinforcement shall be continuous on each end of the bathtub and the back wall. Additionally, backwall reinforcement for a lower grab bar shall be provided with the bottom edge located no more than 6 inches above the bathtub rim. 3) On electrical plan: Receptacles, switches and controls (including controls for heating, ventilation and air conditioning) intended to be used byoccupants shall be located no more than 48 inches measured from the top of the outlet box and not less than 15 inches measured from the bottom of the outlet box above the finish box. 4) Doorbell buttons or controls, when installed, shall not exceed 48 inches above exterior floor or landing, measured from the top of the doorbell button assembly.

Where doorbell buttons integrated with other features

are required to be installed above 48 inches measured

from the exterior floor or landing, a standard doorbell

button or control shall also be provided at a height not exceeding 48 inches above exterior floor or landing,

measured from the top of the doorbell button or control.

ELECTRICAL LEGENDS

© CEILING RECEPTACLE OUTLET

DUPLEX RECEPTACLE, MTD @ 12" U.O.N.

→ SINGLE OUTLET **220**V 220 V OUTLET

₩P WEATHERPROOF DUPLEX OUTLET W/GFGI

GFI DUPLEX OUTLET W/GROUND FAULT INTERRUPTER

DUPLEX RECEPTACLE, MTD@+12" U.O.N. SPLIT WIRE WITH HALF SW/CONTROLLED

SPECIAL PURPOSE

FLOOR DUPLEX RECEPTACLE OUTLET

CARBON MONOXIDE SMOKE DETECTOR W/BATTERY BACK UP

→ CEILING LIGHT

FLUORESCENT LIGHT

RECESSED CANISTER

\$ SWITCH

\$3 3 WAY SWITCH

\$4 4 WAY SWITCH

DIM* DIMMER SWITCH

\$T TIMER SWITCH

CEILING FAN

→ FUEL GAS

FAN TO OUTSIDE AIR

CARBON MONOXIDE SMOKE DETECTOR W/BATTERY BACK UP

- INCANDESCENT LIGHT FIXTURE (CEILING)

WEATHERPROOF LIGHT FIXTURE

DISPOSAL

O RECESSED LIGHT FIXTURE

FAN TO OUTSIDE AIR

OOO CHIME

PUSH BUTTON

HB HORSE BID WITH BACKFLOW PREVENTATION → DEVICE

HB ⊢+ HOSE BIBB SOV SHUT OFF VALVE

∘□\ BELL / BUZZER

ELECTRICAL DISCONNECT

DECORATIVE ABOVE MIRROR

BATHROOM LIGHT USD CIRCUIT BREAKER

₩ KEY

MOTION SENSOR


CHANDELIER

FLOOR SUPPLY AIR REGISTER

CEILING SUPPLY AIR REGISTER FLOURESCENTLIGHT FIXUTE (SURFACE) SEE PLAN

CO DETECTORS U.L./SFM LISTED APPROVED



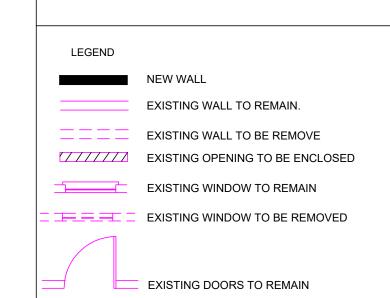



GRAPHIC DESIGN 9743 WHITE PINE WAY, ELK GROVE, CA 95624

Tell: (916) 526-5881 & (408) 876-8402

Email: helennguyen3689@gmail.com

Scale: AS SHOWN

Date: AUGUST 2024

Drawn: LUYEN HONG NGUYEN

Signed: Thuy


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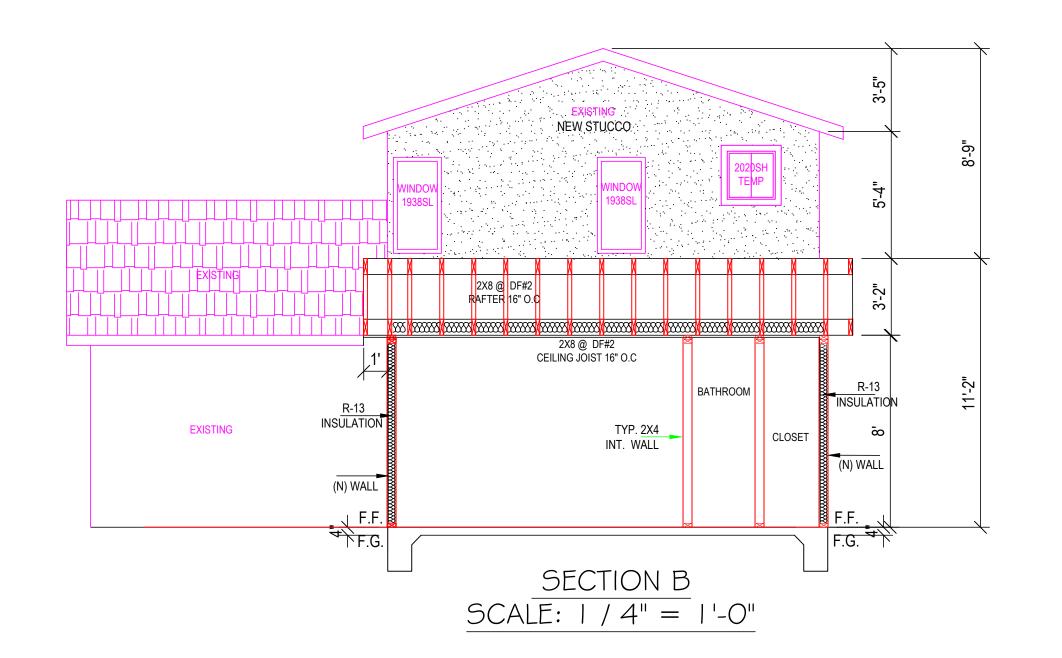
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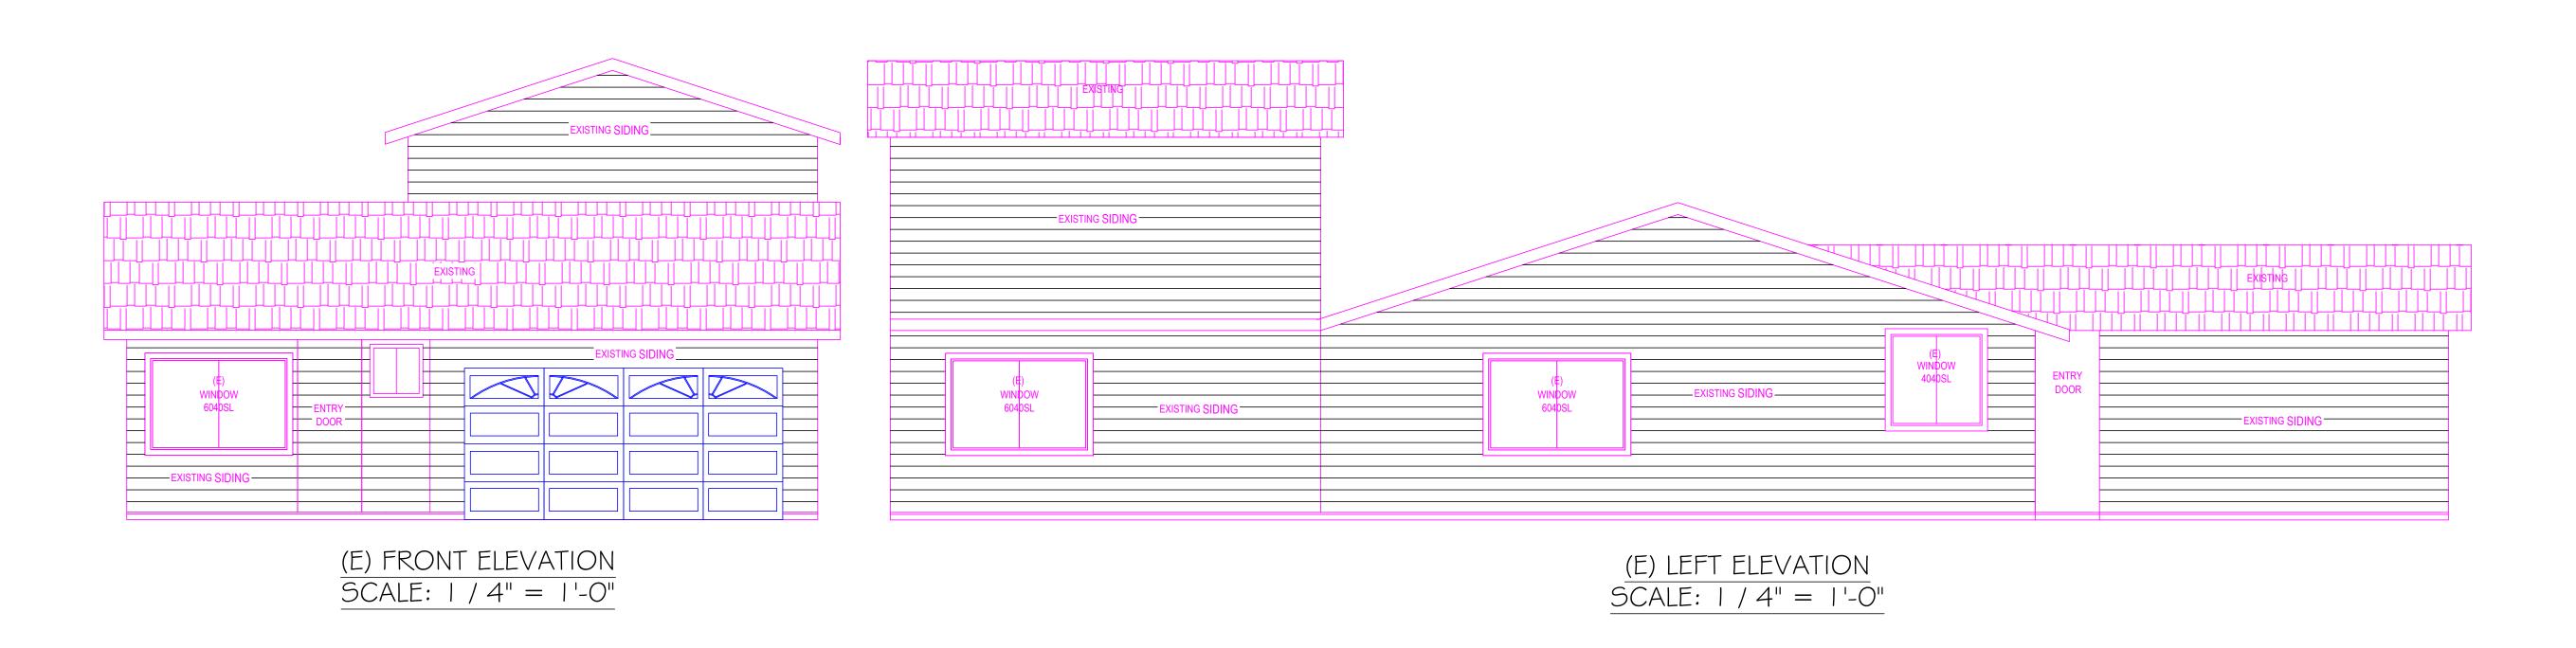
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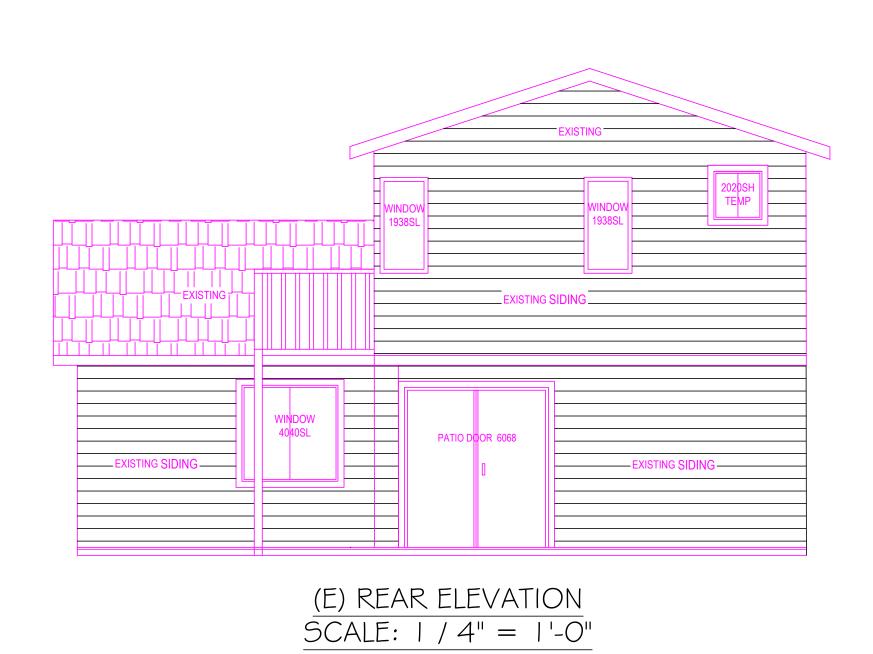
SECTION PLAN
THUY NGUYEN'S RESIDENCE
6322 STACY AVE,
SACRAMENTO CA, 95823


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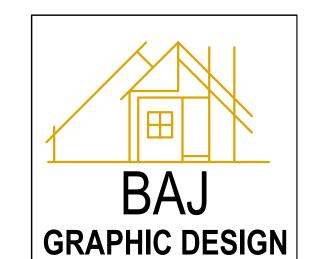
A-4





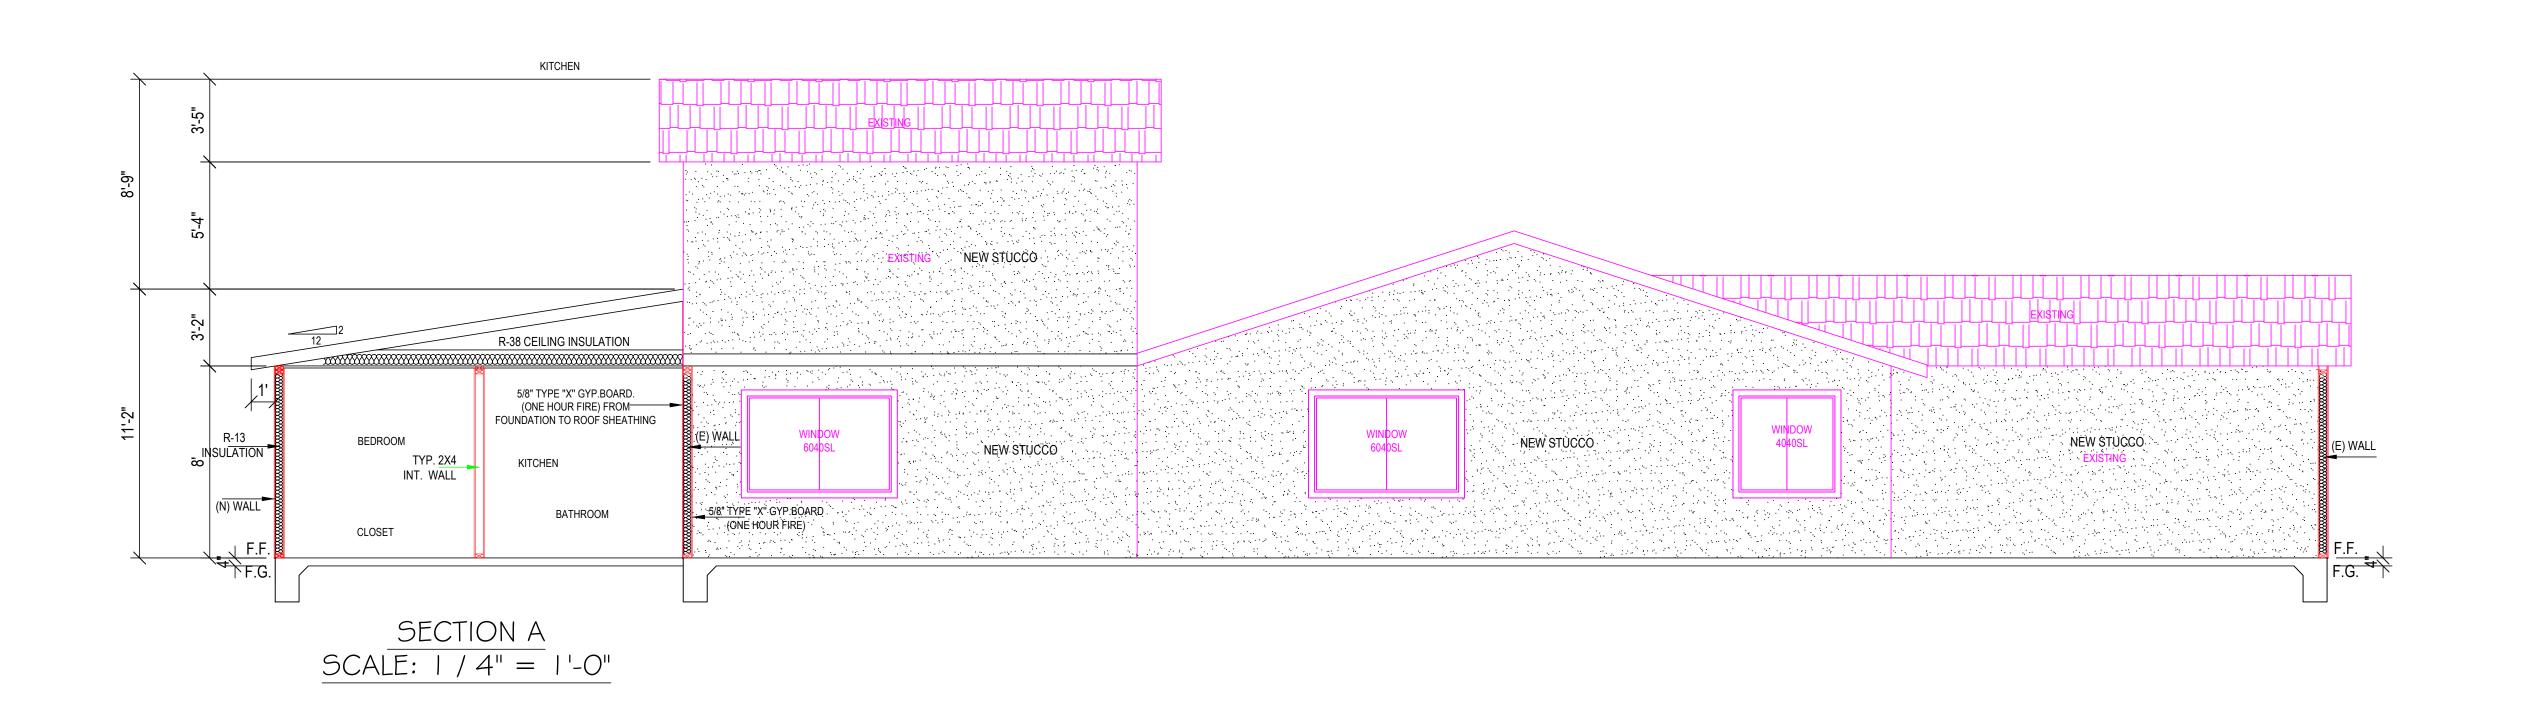

(E) RIGHT ELEVATION SCALE: 1/4" = 1'-0"

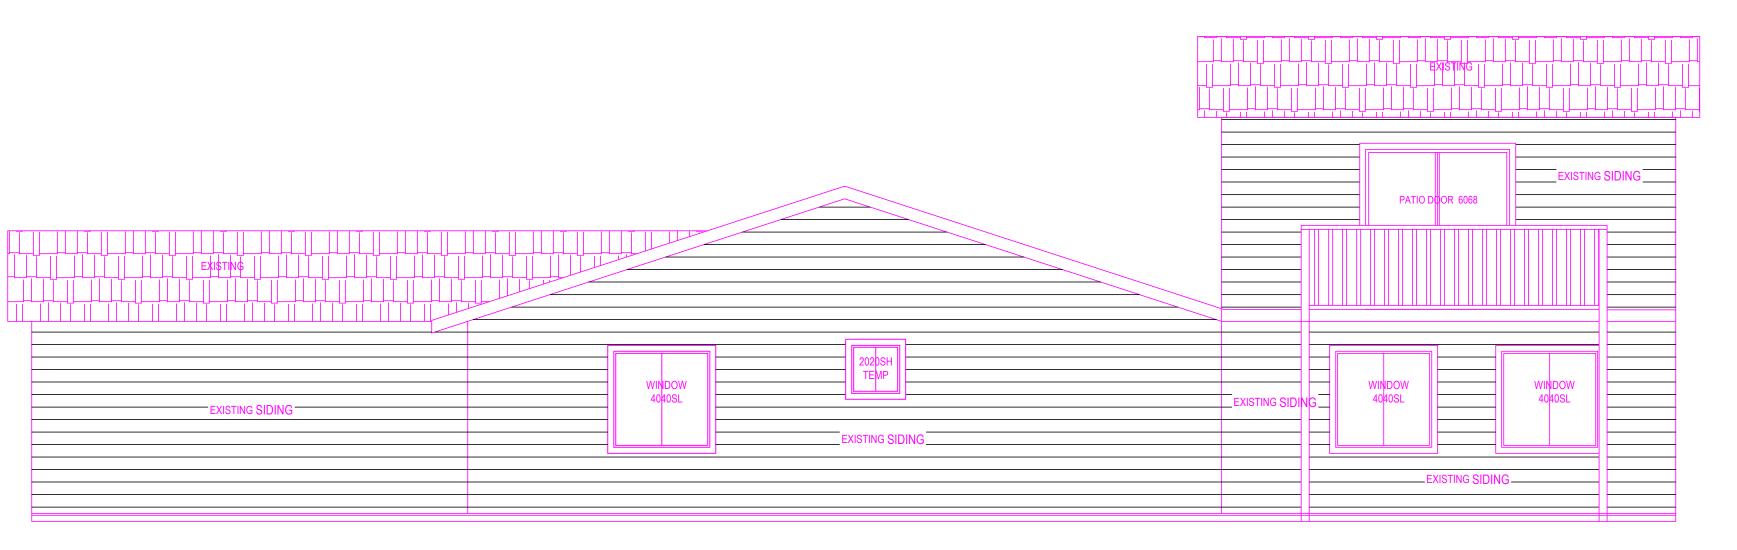

9743 WHITE PINE WAY, ELK GROVE, CA 95624 Email: helennguyen3689@gmail.com Tell: (916) 526-5881 & (408) 876-8402

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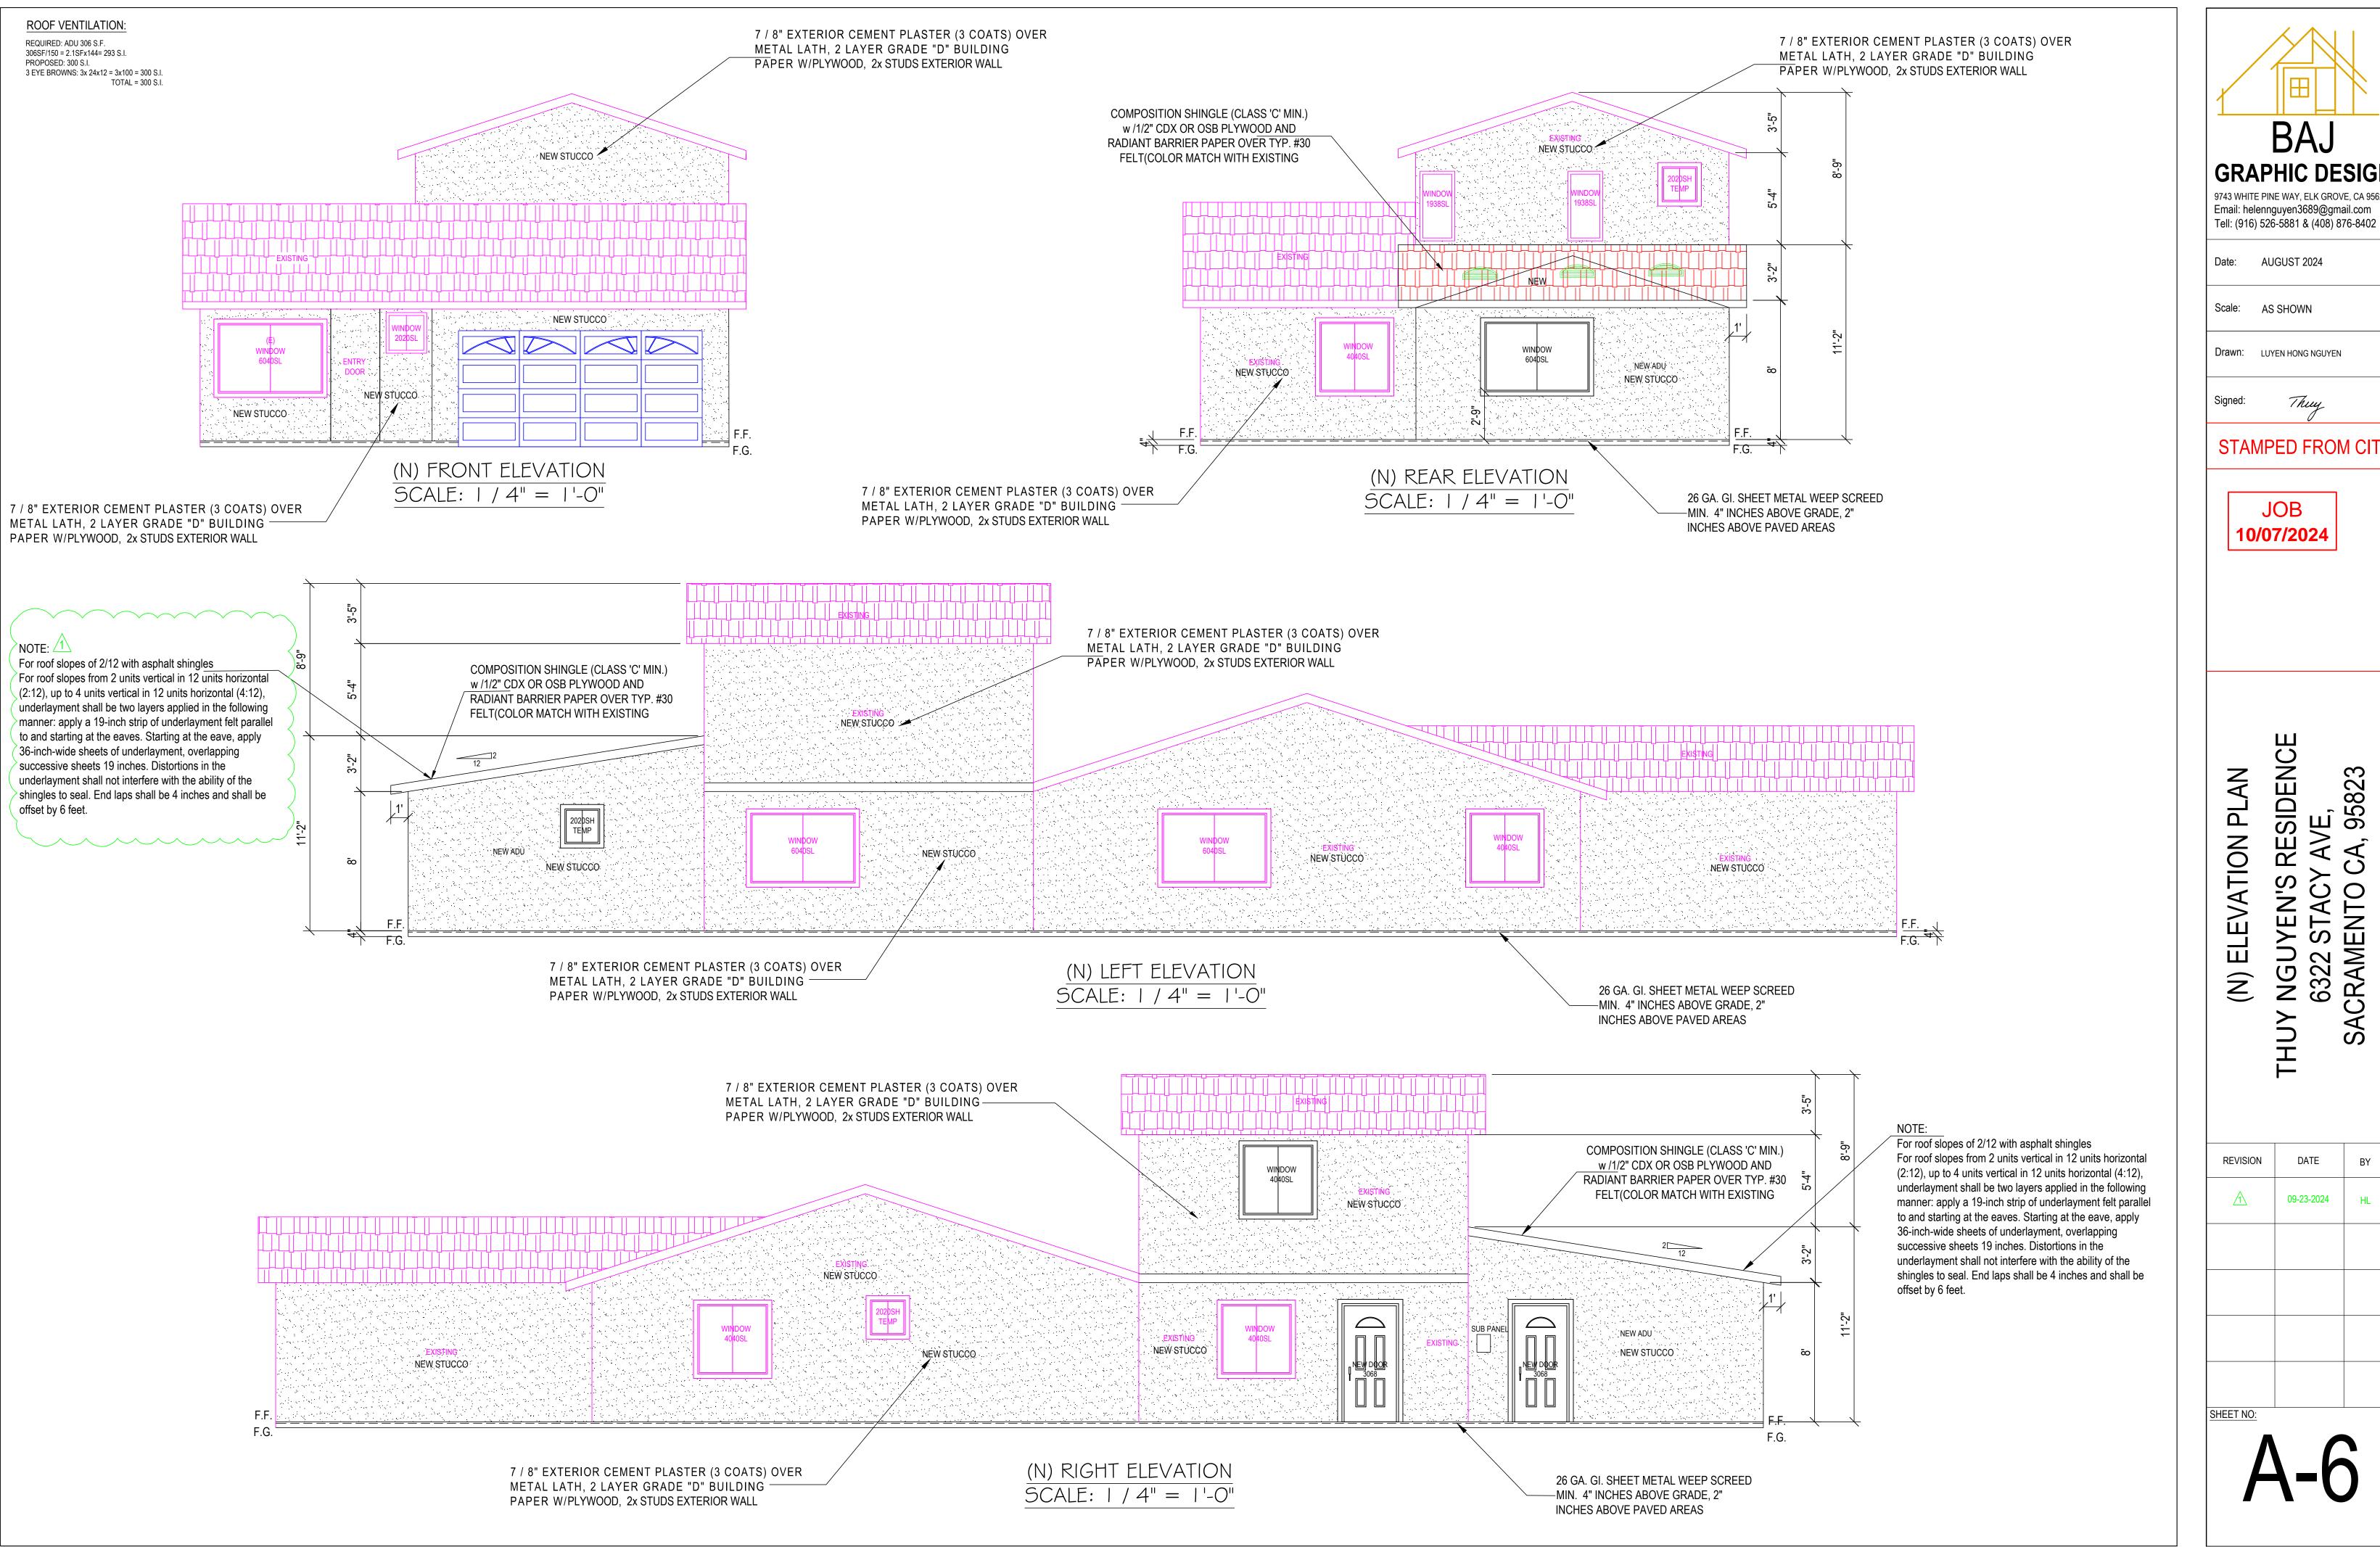
(E) ELEVATION PLAN

HUY NGUYEN'S RESIDENCE
6322 STACY AVE,

SACRAMENTO CA, 95823

REVISION	DATE	BY
SHEET NO:		

A-5





GRAPHIC DESIGN 9743 WHITE PINE WAY, ELK GROVE, CA 95624 Email: helennguyen3689@gmail.com

Date: AUGUST 2024

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Drawn: LUYEN HONG NGUYEN

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