
# MYCHAEL VO & WENDY HOANG'S RESIDENCE 1340 VIA DONDERA SANTA CLARA, CA 95051

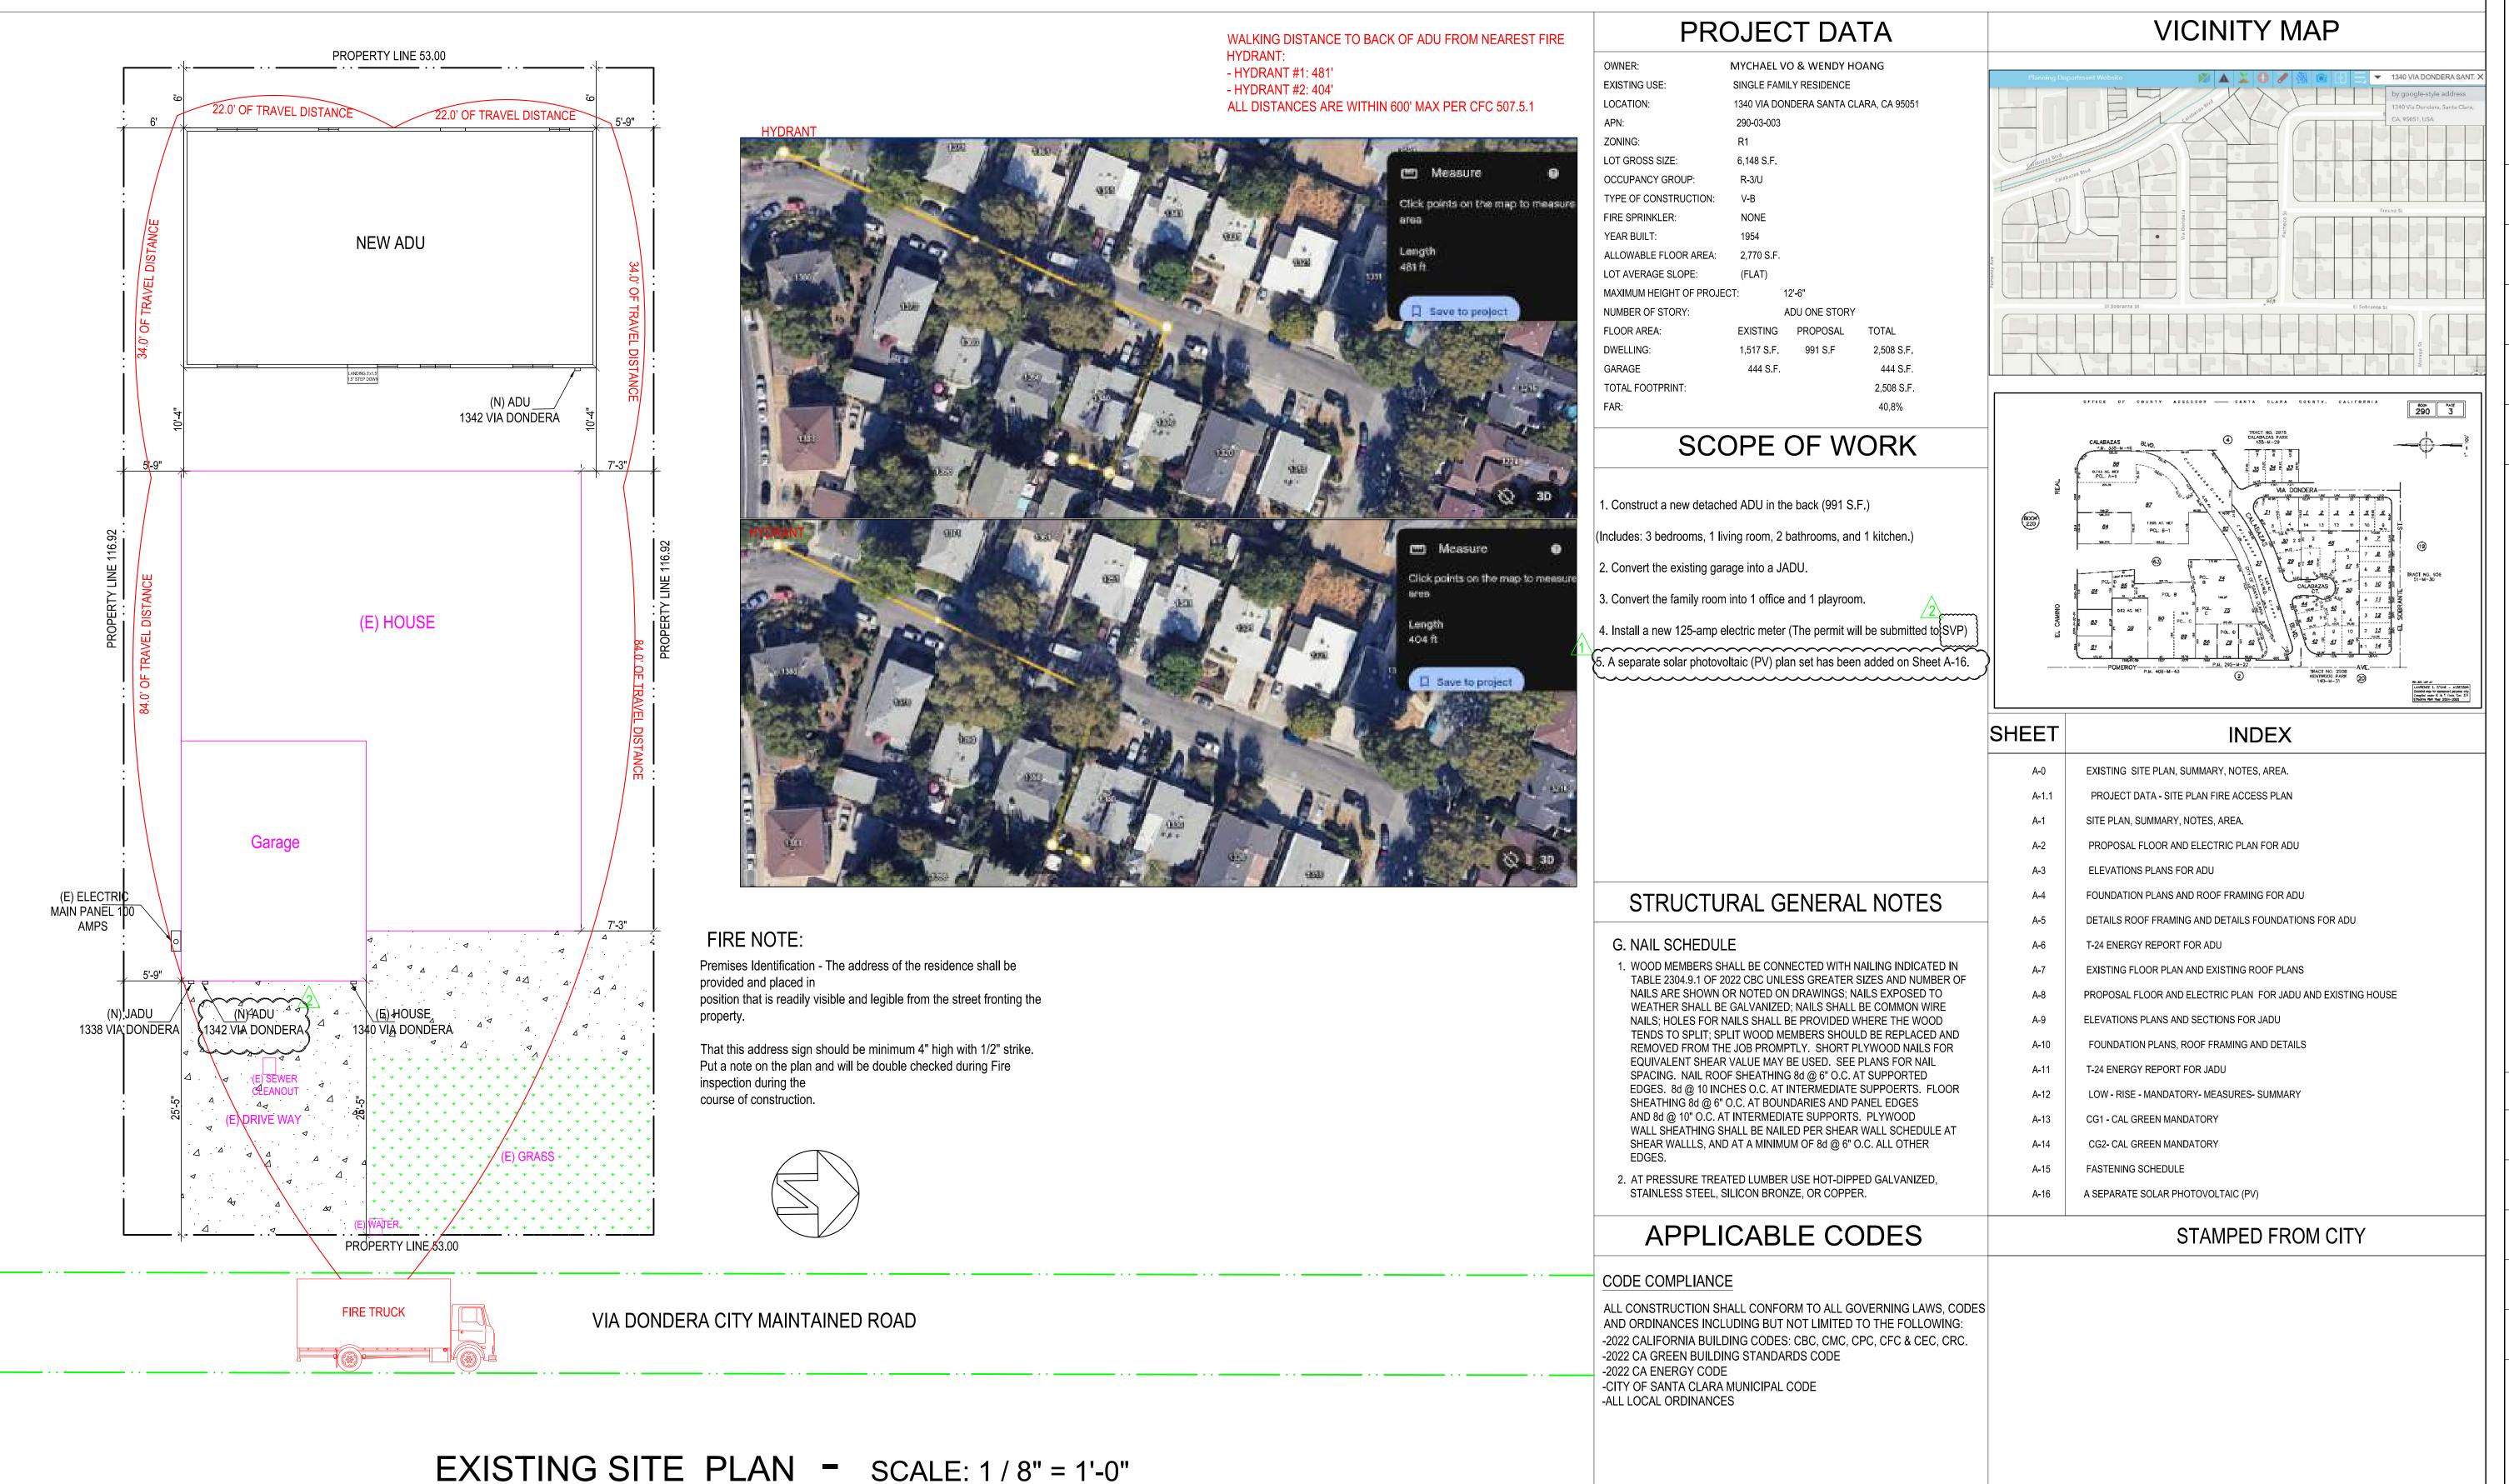

BLD25-01049

REVIEWED FOR CODE
COMPLIANCE
City of Santa Clara Building Division
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07/30/2025 12:02:23 PM

STAMPED FROM CITY



Date: APRIL 2025

Drawn: LUYEN HONG NGUYEN

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ST DATA - SITE PLAN
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## MYCHAEL VO & WENDY HOANG'S RESIDENCE 1340 VIA DONDERA SANTA CLARA, CA 95051

#### STRUCTURAL GENERAL NOTES PROJECT DATA **VICINITY MAP** Water Supply Load Calculation CROSSING PROPERTY LINES, TYP. This document presents the water supply load calculation for the Duplex and ADUs. PLACE STRAW ROLLS AROUND MYCHAEL VO & WENDY HOANG A. GENERAL CONSTRUCTION AREA, TYP. **EXISTING USE:** SINGLE FAMILY RESIDENCE CONTRACTOR SHALL GRADE LOT 1. ALL WORK SHALL CONFORM TO CURRENT 2022 CBC, CBC, CMC, CPC, LOCATION: 1340 VIA DONDERA SANTA CLARA, CA 95051 TO PREVENT DRAINAGE FROM 2022 NEC, 2022 CEC.LAWS & ORDINENCES 2. THE CONTRACTOR SHALL VERIFY & BE RESPONSIBLE FOR ALL DIMENTIONS & CONDITIONS AT THE JOB SITE AND SHALL NOTIFY LOT GROSS SIZE: 6.148 S.F. THE ARCHITECT OF ANY DESCREPANCIES BETWEEN ACTUAL CONDITIONS & WHAT IS SHOWN ON THE DRAWINGS BEFORE OCCUPANCY GROUP: R-3/U PROCEDING WITH THE WORK. TYPE OF CONSTRUCTION: PROPERTY LINE 53.00 3. ANY OMISSIONS OR CONFLICTS BETWEEN THE ARCHITECTURAL FIRE SPRINKLER: STRUCTURAL & MECHANICAL DRAWINGS SHALL BE BROUGHT TO THE ATTENTION OF THE CITY INSPECTOR. DOWNSPOUT W/ MIN.5% SLOPE FROM BLDG WITHIN 10 FEET, TYP. ALLOWABLE FLOOR AREA: SPLASH BLOCK SPLASH BLOCK 4. SHOP DRAWINGS REQUIRED BY THE SPECIFICATIONS SHALL BE LOT AVERAGE SLOPE: SUBMITTED TO THE ARCHITECT PRIOR TO FABRICATION, & ALLOW REASONABLE TIME FOR REVIEW AND APPROVAL BY THE STRUCTURAL MAXIMUM HEIGHT OF PROJECT: NUMBER OF STORY ADU ONE STORY Provide a dedicated 1" EMT conduit from the mair electrical panel to a designated junction box for 5. THE CONTRACTOR SHALL BE RESPONSIBLE FOR THE SAFTEY OF THE FLOOR AREA: future battery storage installation (up to 5kWh). BUILDING DURING THE CONSTRUCTION. THE CONTRACTOR SHALL Raceway shall comply with Santa Clara County PROVIDE ADEQUATE SHORING, BRACING & GUYS IN ACCORDANCE Ordinance No. NS-1100 135 and California WITH ALL NATIONAL, STATE AND LOCAL SAFETY ORDANCES. ANY Electrical Code (CEC) DEVIATIONS MUST BE APPROVED PRIOR TO ERECTION. TOTAL FOOTPRINT 2,508 S.F 6. ALL CONDITIONS NOT CLEARLY SHOWN OR DETAILED SHALL BE OF SLOPE OF ROOF 4:12 THE SAME TYPE & CHARACTER AS THOSE SHOWN FOR SIMILAR O 1 HR, FIRE-ROOF EAVE NEW ADU 41'-3"-24'-0" SCOPE OF WORK **B. FOUNDATION** DOWNSPOUT W/ SPLASH BLOCK 1. FOUNDATION EXCAVATIONS SHALL BE FREE OF LOOSE MATERIAL PRIOR TO THE PLACEMENT OF ANY REINFORCING STEEL OR CONCRETE. 1. Construct a new detached ADU in the back (991 S.F.) C. CONCRETE MIN 5% SLOPE FROM BLDG WITHIN 10 FEET. TYP (Includes: 3 bedrooms, 1 living room, 2 bathrooms, and 1 kitchen.) 1. ALL CONCRETE SHALL HAVE A MINIMUM COMPRESSIVE STRENGTH OF SPLASH BLO 2. Convert the existing garage into a JADU. 2. CONCRETE SHALL BE REGULAR WEIGHT HARD ROCK TYPE(150#CF) & AGREGATE SHALL CONFORM TO ASTM C33 U.O.N. 3. Convert the family room into 1 office and 1 playroom 3. CEMENT SHALL CONFORM TO ASTM C150, TYPE 1 OR 2. 4. Install a new 125-amp electric meter (The permit will be submitted to SVP) 4. PLACEMENT OF CONCRETE SHALL BE IN CONFORMANCE WITH ACI 301. P.M. 235 M-22 P.M. 235 M-22 19-30 80 80 62-17 75-27 1/30 1/300 1/300/0 A separate solar photovoltaic (PV) plan set has been added on Sheet A-16. POMEROY P.M. 408-M-43 5. CONCRETE SHALL BE MACHINE MIXED AND DELIVERED IN ACCORDANCE WITH ASTM C-94. SUBMIT MIX DESIGN TO THE ARCHITECT FOR APPROVAL PRIOR TO PLACING CONCRETE. 6. PROVIDE MINIMUM CLEAR COVER OF CONCRETE OVER REINFORCING SHEET **INDEX** AS FOLLOWS D. REINFORCING STEEL S.S. (E) HOUSE EXISTING SITE PLAN, SUMMARY, NOTES, AREA. 1. ALL REINFORCING STEEL SHALL CONFORM TO ASTM SPECIFICATION PROJECT DATA - SITE PLAN FIRE ACCESS PLAN A615 GRADE 60 FOR #5 AND LARGER BARS AND GRADE 40 FOR SITE PLAN, SUMMARY, NOTES, AREA. N) ELECTRIC 2. ALL REINFORCING STEEL SHALL BE LAPPED AS NOTED BELOW. **METER PANEL -**PROPOSAL FLOOR AND ELECTRIC PLAN FOR ADU #4: 24" FOR BOTTOM BARS AND 28" FOR TOP BARS; #5: 30" FOR 125 AMPS FOR BOTTOM BARS AND 35" FOR TOP BARS; #6: 40" FOR BOTTOM BARS ELEVATIONS PLANS FOR ADU AND 46" FOR TOP BARS AT SPLICES UNLESS OTHERWISE NOTED ON Panel dimensions: FOUNDATION PLANS AND ROOF FRAMING FOR ADU STRUCTURAL GENERAL NOTES PLANS. SPLICES SHALL BE LOCATED AS DETERMINED IN THE PLANS. 16"W x 42"H x 6"D STAGGER ALL LAPS SPLICES. DETAILS ROOF FRAMING AND DETAILS FOUNDATIONS FOR ADU (approx.) Surface-mounted 3. WELDED WIRE FABRIC SHALL CONFORM TO ASTM A82 AND A185. G. NAIL SCHEDULE T-24 ENERGY REPORT FOR ADU and grouped next 4. ANCHOR BOLTS, DOWELS AND OTHER EMBEDDED ITEMS SHALL BE to main house 1. WOOD MEMBERS SHALL BE CONNECTED WITH NAILING INDICATED IN EXISTING FLOOR PLAN AND EXISTING ROOF PLANS SECURELY TIED IN PLACE BEFORE CONCRETE IS PLACED, USE CYT TABLE 2304.9.1 OF 2022 CBC UNLESS GREATER SIZES AND NUMBER OF Convert 444 S.F. of the THREAD ANCHOR BOLTS ONLY. FIRE NOTE: NAILS ARE SHOWN OR NOTED ON DRAWINGS; NAILS EXPOSED TO PROPOSAL FLOOR AND ELECTRIC PLAN FOR JADU AND EXISTING HOUSE WEATHER SHALL BE GALVANIZED; NAILS SHALL BE COMMON WIRE E. STRUCTURAL & MISC. STEEL Premises Identification - The address of the NAILS; HOLES FOR NAILS SHALL BE PROVIDED WHERE THE WOOD ELEVATIONS PLANS AND SECTIONS FOR JADU TENDS TO SPLIT; SPLIT WOOD MEMBERS SHOULD BE REPLACED AND residence shall be provided and placed in The house and the 1. FABRICATION AND ERECTION TO BE IN ACCORDANCE WITH LATEST FOUNDATION PLANS, ROOF FRAMING AND DETAILS 1342 VIA DONDERA REMOVED FROM THE JOB PROMPTLY. SHORT PLYWOOD NAILS FOR position that is readily visible and legible from ADU shall each AISC SPECIFICATIONS. STRUCTURAL STEEL SHALL BE ASTM A36, EQUIVALENT SHEAR VALUE MAY BE USED. SEE PLANS FOR NAIL have a separate the street fronting the property. T-24 ENERGY REPORT FOR JADU EXCEPT TUBE COLUMNS WHICH ARE ASTM A500, GRADE B. ANEL 125 AMPS OF ADU SPACING. NAIL ROOF SHEATHING 8d @ 6" O.C. AT SUPPORTED electric service EDGES. 8d @ 10 INCHES O.C. AT INTERMEDIATE SUPPOERTS. FLOOR LOW - RISE - MANDATORY- MEASURES- SUMMARY 2. WELDING TO BE IN ACCORDANCE WITH AWS SPECIFICATIONS. disconnect. SHEATHING 8d @ 6" O.C. AT BOUNDARIES AND PANEL EDGES That this address sign should be minimum 4" WELDING SHALL BE PERFORMED BY CERTIFIED WELDERS USING Each disconnect AND 8d @ 10" O.C. AT INTERMEDIATE SUPPORTS. PLYWOOD high with 1/2" strike. CG1 - CAL GREEN MANDATORY E77XX ELECTRODES. WALL SHEATHING SHALL BE NAILED PER SHEAR WALL SCHEDULE AT shall be installed Put a note on the plan and will be double 3. ALL PLATES, ETC., TO BE BOLTED TO CONCRETE ELEMENTS, SHALL SHEAR WALLLS, AND AT A MINIMUM OF 8d @ 6" O.C. ALL OTHER CG2- CAL GREEN MANDATORY in a separate checked during Fire inspection during the NOT BE FABRICATED UNTIL THE BOLTS HAVE BEEN LOCATED IN THE enclosure and course of construction. 1340 VIA DONDERA 1338 VIA; DONDERA √ \$1342 VIA DONDERA« grouped near 2. AT PRESSURE TREATED LUMBER USE HOT-DIPPED GALVANIZED, STAINLESS STEEL, SILICON BRONZE, OR COPPER. 4. BOLTS SHALL BE ASTM A307 TYPE. THREADS MAY BE INCLUDED IN each other. A SEPARATE SOLAR PHOTOVOLTAIC (PV) THE SHEAR PLANES A permanent address label is APPLICABLE CODES 5. STEEL TO BE SHOP PRIMED FOR, EXCEPT WHERE EMBEDDED IN STAMPED FROM CITY required to be CONCRETE OR TO BE WELDED. provided at each 6. ALL WELDING SHALL BE CONTINUOUSLY INSPECTED BY AN INDEPENDENT INSPECTOR APPROVED BY THE BUILDING DEPARTMENT. CODE COMPLIANCE disconnect." ALL CONSTRUCTION SHALL CONFORM TO ALL GOVERNING LAWS, CODES F. WOOD FRAME CONSTRUCTION AND ORDINANCES INCLUDING BUT NOT LIMITED TO THE FOLLOWING: Provide minimum 36" 1. GENERAL WOOD FRAMING: WOOD FRAMING THROUGHOUT THE BUILDING -2022 CALIFORNIA BUILDING CODES: CBC, CMC, CPC, CFC & CEC, CRC. working clearance in front of SHALL BE CONSTRUCTED IN ACCORDANCE WITH CALIFORNIA BUILDING -2022 CA GREEN BUILDING STANDARDS CODE each electric panel per NEC CODE (2022) CBC ADOPTED BY CSJ. AND THE STANDARD PRACTICES RECOMENDED BY -2022 CA ENERGY CODE AMERICAN INSTITUTE OF TIMBER CONSTRUCTION AND WCLA GRADING -CITY OF SANTA CLARA MUNICIPAL CODE FOR NAILING SEE SECTION J. BOLTS IN WOOD FRAMING SHALL BE Panels shall be -ALL LOCAL ORDINANCES STANDARD MACHINE BOLTS WITH STANDARD MALLEABLE IRON WASHERS surface-mounted and - VIA DONDERA CITY MAINTAINED ROAD

SITE PLAN - SCALE: 1 / 8" = 1'-0"

3. WOOD PLATES: BEARING DIRECTLY UPON CONCRETE SHALL BE P.T.D.F.

4. UNLESS OTHERWISE NOTED ON DRAWINGS OR IN SPECIFICATIONS, FRAMING MEMBERS SHALL HAVE THE FOLLOWING GRADING:

grouped side-by-side, facing ?

the same direction."

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### FLOOR PLAN NOTES:

- ALL CONCRETE TO BE POURED ON UNDISTURBED SOIL.
- 2. ALL LUMBER IN CONTACT WITH CONCRETE SHALL BE FOUNDATION GRADE RWD OR PRESSURE TREATED.
- 3. ALL LUMBER USED IN CONSTRUCTION LOCATED NEARER THAN 8" TO EARTH SHALL BE F.G. RWD OR P.T.
- 4. PROVIDE SOLID BLOCKING FOR ALL PONY WALLS LESS THAN 14" HIGH 5. PROVIDE FIRESTOPS @ CONCEALED DRAFT OPENING, CEILING LINES, FLOOR LINES, FURRED AREAS, SUSPENDED CEILINGS, STAIR STRINGERS, SHOWERS. CHIMNEY ENCLOSURES, & MID HEIGHT OF WALLS OVER 10' IN HEIGHT.
- 6. VERIFY MIN. 22"x30" FLOOR ACCESS. ATTIC ACCESS WITH 30" CLEARING ABOVE OPENING.
- 7. DOORS, WINDOWS, & SHOWER DOORS WITHIN HAZARDOUS AREAS TO BE
- 8. ALL POSTS, BEAMS & WALLS SUPPORTING THE FLOOR/ CEILING SHALL HAVE
- ONE-HOUR FIRE PROTECTION. 9. ALL NEW WINDOWS AND GLASS SLIDING DOOR SHALL BE LOW-E DUAL
- GLAZED U.N.O. 10. MATERIAL GRADE STAMPS WILL BE CHECKED ON FRAME INSPECTION.
- 11. ALL CONSTRUCTION SHALL COMPLY WITH THE 2022 EDITION OF THE CBC, CMC, CPC, CEC, CRC AND CFC AND THE 2022 CALIFORNIA ENERGY CODE.
- 12. CHANGES FROM THE APPROVED PLANS DURING CONSTRUCTION OTHER THAN 1.) CABINET CHANGES WHEN NOT BEING SUPPORTED ENTIRELY BY THE ROOF STRUCTURE, APPROVED PLAN, 2.) INTERIOR NON-STRUCTURAL WALL FINISHES; SHALL CAUSE PLAN APPROVAL AND CONSTRUCTION TO BE SUSPENDED. A NEW PLAN CHECK (FOR A NEW PLAN) SHOWING CHANGES WILL BE SUBMITTED FOR REVIEW AND APPROVAL THROUGH THE NORMAL PLAN CHECK PROCESS.
- 13. FIREBLOCKING WITH NON-COMBUSTIBLE MATERIAL SHALL BE PROVIDED IN OPENINGS AROUND VENTS, PIPES, DUCTS, FIREPLACES, AND SIMILAR OPENINGS PER CBC 708.2.1 (4).
- 14. PROVIDE SMOKE DETECTORS (HARDWIRED 110v W/BATT BACK-UP) IN EVERY BEDROOMS, THE HALL WAY TO THE BEDROOM, PROVIDE CARBON MONOXIDE SMOKE ALARM DETECTOR IN ALL SLEEPING ROOM.
- 15. IN EACH NEW BEDROOM, THERE IS AT LEAST ONE WINDOW, FOR EMERGENCY ESCAPE OR RESCUE: REQUIRE OPENING OF MINIMUM NET CLEAR AREA, 5.7 SQ. FT. HEIGHT 24", WIDTH 20", AND MAXIMUM FINISHED OPENING HEIGHT 44"ABOVE FINNISH FLOOR
- 16. NEW 3'X3' MIN, CONCRETE LANDING AT ALL NEW EXTERIOR DOOR. LANDING SHALL NOT BE LOWER THAN 7-1/2" FROM FLOOR LEVEL.
- 17. BATHROOM SLIDING DOOR MUST BE TEMPERED GLASS.
- 18. ALL NEW BEDROOM MUST BE AFCI CIRCUIT.
- 19. PRESSURE OR THERMOSTATIC MIXING VALVE AT THE SHOWERS AND TUBS, WHICH LIMIT WATER TEMPERATURE TO 120 DEGREES F
- 20. THE SHOWERS MUST HAVE INSIDE DEMENSION OF AT LEAST 30 INCHES, THE TOTAL FLOOR AREA OF A SHOWER MUST BE AT LIST 1,024 SQUARE INCHES, OPENING TO SHOWER MUST BE MIN. 24 INCHES WIDE, THE DOOR MUST BE TEMPERED GLASS.(SEE DETAILS)

### ELECTRICAL NOTES:

- MOTION SENSOR WITH INTEGRAL PHOTOCONTROL
- 2. ALL HARDWIRED LIGHTING IN BED ROOMS BATHROOMS, GARAGES, LAUNDRY AND UTILITY ROOMS MUST BE HIGH EFFICACY CONTROLLED BY A MANUAL-ON MOTION SENSOR (ALL NEW LIGHTS MUST BE HIGH EFFICACY 2022 ENERGY CODE).
- 3. ALL HARDWIRED LIGHTING IN OTHER ROOMS (HALLWAYS, DINING ROOMS, FAMILY ROOMS AND BEDROOMS) SHALL BE HIGH EFFICACY CONTROLLED BY A MANUAL-ON OCCUPANT SENSOR A DIMMER MUST CONTROL IT (ALL NEW LIGHTS MUST BE HIGH EFFICACY 2022 ENERGY CODE).
- 4. ALL SWITCHES ON A MULTIPLE SWITCHED CIRCUIT SHALL BE CONTROLLED BY THE DIMMER SWITCH ON THAT CIRCUIT
- 5. ALL RECESSED FIXTURES SHALL BE LABELED AS BEING CERTIFIED TO HAVE A LEAKAGE RATING OF LESS THAN 2.0 AT 75 PASCAL
- 6. ALL HIGH EFFICACY FIXTURES AND NON-HIGH EFFICACY FIXTURES SHALL BE SWITCHED SEPARATELY
- 7. SMOKE DETECTOR SYSTEM SHALL BE HARD-WIRED, INTERCONNECTED TO SOUND SIMULTANIOUSLY AND EQUIPED WITH BATTERY BACK UP.
- 8. MIN. 100% OF WATTAGE OF LIGHTS IN KITCHEN SHALL BE HIGH EFFICACY AND THOSE THAT ARE NOT SHALL BE SWITCHED SEPARATELY 9. LIGHTS MOUNTED TO EXTERIOR OF BUILDING SHALL BE HIGH EFFICACY OR ON A PHOTO CONTROL/MOTION SENSOR COMBINATION
- LAMP POWER RATING: MINIMUM LAMP EFFICACY: 15 watts or less 40 lumens per watt over 15 watts to 40 watts 50 lumens per watt over 40 watts 60 lumens per watt

## NOTES:

WATER-RESISTANT GYPSUM BACKING BOARD SHALL NOT BE USED WHERE THERE WILL BE DIRECT EXPOSURE TO WATER. OR IN AREAS SUBJECT TO CONTINUOUS HIGH HUMINITY . R702.3.7.1

on plan the fire-resistance-rated floor/ceiling and wall assemblies shall wall, and wall assemblies shall extend from the foundation to the underside of the roof sheathing or rated floor/ceiling

Water Fixture Flow Rate Requirements (Water Conservation) Note: All plumbing fixtures must meet the maximum flow rates below to comply with California Plumbing Code (CPC) water conservation standards. 1. Toilet • Max flow rate: 1.28 GPF (Gallons per flush) • Code: CPC 403.2.1 2. Kitchen Faucet • Max flow rate: 1.8 GPM (Gallons per minute) • Code: CPC 407.2.1.1 3. Residential Lavatory Faucet • Max flow rate: 1.2 GPM • Code: CPC 407.2.1.1

4. Shower Head • Max flow rate: 1.8 GPM • Code: CPC 408.2


NSP - Windows/Doors Maximum U-Factor 0.30. Maximum SHGC 0.23 for Zone 12 only. NFRC labels are required for all windows & Doors.

ALL 120-VOLT, SINGLE PHASE, 15 AND 20 AMPERE BRANCH CIRCUITS SUPPLYING OUTLETS INSTALLED IN DWELLING UNIT KITCHENS, FAMILY ROOMS, DINING ROOMS' LIVING ROOMS' PARLORS, LIBRARIES, DENS, BEDROOMS, SUNROOMS, RECREATION ROOMS. CLOSETS, HALLWAYS, LAUNDRY AREAS, OR SIMILAR ROOMS OR AREAS SHALL BE PROTECTED BY A LISTED ARC-FAULT CIRCUIT INTERRUPTER. COMBINATION-TYPE, INSTALL TO PROVIDE PROTECTION OF THE BRANCH CIRCUIT.

1.USE 'DUROCK', WONDERBOARD', OR AN APPROVED EQUAL BEHIND GLUED-ON TILE IN TUB, BATH, OR SHOWER AREAS. 2. SEPARATE SEWER LATERAL PERMIT AND INSPECTIONS REQUIRED FROM DOT PRIOR TO CONNECTING.

ALL ELECTRICAL RECEPTACLE OUTLETS, SWITCH, AND CONTROLS (INCLUDING CONTROLS FOR HEATING, VENTILATION.AND AIR CONDITIONING) INTENDED TO BE USED BY OCCUPANTS SHALL BE LOCATED NOT MORE THAN 48 INCHES MEASURED TO THE TOP OF THE OUTLET BOX AND NOT LESS THAN 15 INCHES MEASURED TO THE BOTTOM OF THE OUTLET BOX AND ABOVE THE FINNISH FLOOR PER SECTION R327.1.2 AGING IN PLACE

REQUIREMENTS. PLEASE SEE SECTION FOR

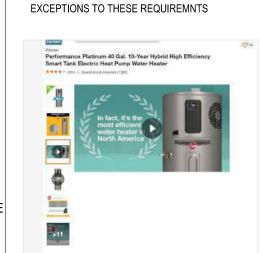

MIN, SHOWER INTERIOR CLEAR DIMENSION IS

SHOWER AND TUB/SHOWER WALLS TO

NONABSORBENT SURFACE(I.E. CERAMIC

FIBER-CEMENT OR GLASS MAT GTMSUM

BACKERS) TO A HEIGHT OF 72" ABOVE

—CERAMIC TILES

CEMENT BOARD

OR MOTAR BASE

SHOWER PAN LINER TO EXTEND AT LEAST 3"

ABOVE CURD

MIN.SLOPE=1/ 4":12"

MAX,SLOPE=1/ 2":12"

MOTAR BED-

MIN. 1/4:12: TO DRAIN

1 N.T.S.

SHOWER PAN LINES ON -

MOTAR BED-SLOPE LINES

- WATER PROOF

MEMBRANE

TILES) OVER MOISTURE RESISTANT UNDERLAYMENT(I.E. CEMENT,

SPECIFY A SMOOTH, HARD,

THE DRAIN.

1,024 S.F. IN WITH NO DIMENSION LESS THAN

BATHROOM DOOR MUST BE TEMPERED CLASS

NOTE: ALL ELECTRICAL RECEPTACLE OUTLETS, SWITCH, AND CONTROLS (INCLUDING CONTROLS FOR HEATING, VENTILATION.AND AIR CONDITIONING) INTENDED TO BE USED BY OCCUPANTS SHALL BE LOCATED NOT MORE THAN 48 INCHES MEASURED TO THE TOP OF THE OUTLET BOX AND NOT LESS THAN 15 INCHES MEASURED TO THE BOTTOM OF THE OUTLET BOX AND ABOVE THE FINNISH FLOOR PER SECTION R327 1.2 AGING IN PLACE REQUIREMENTS. PLEASE SEE SECTION FOR EXCEPTIONS TO THESE REQUIREMNTS



Aging-In Design note added For reinforcement installation: a) Reinforcement shall not be less than 2x8 nominal lumber or other construction material providing equal height and load capacity.Reinforcement shall be located between 32 inches and 39-1/4 inches above the finish floor flush with the wall framing

b) Water closet reinforcement shall be installed on both side walls of the fixture, or one side wall and the back

c) Shower reinforcement shall be continuous where wall framing is provided. d) Bathtub and combination bathtub/shower reinforcement shall be continuous on each end of the bathtub and

the back wall. Additionally, backwall reinforcement for a lower grab bar shall be provided with the bottom edge located no more than 6 inches above the bathtub rim. 3) On electrical plan: Receptacles, switches and controls (including controls for heating, ventilation and air conditioning) intended to be used byoccupants shall be located no more than 48 inches measured from the top of the outlet box and not less than 15 inches measured from the bottom of the outlet box above the finish box. 4) Doorbell buttons or controls, when installed, shall not exceed 48 inches above exterior floor or landing, measured from the top of the doorbell button assembly. Where doorbell buttons integrated with other features are required to be installed above 48 inches measured from the exterior floor or landing, a standard doorbell button

or control shall also be provided at a height not exceeding 48 inches above exterior floor or landing, measured


from the top of the doorbell button or control.

RUN SHOWER PAN

LINER UP AND

- SHOWER DRAIN W/ SUB-DRAIN

OVER CURB

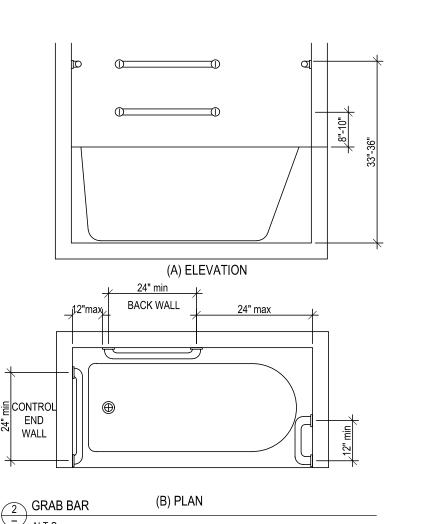


COLD WATER SUPPLY

RUN SHOWER PAN LINER

UP AND OVER CURB

## PROPOSAL FLOOR PLAN ADU 991 S.F. SCALE: 1/4" = 1'-0"

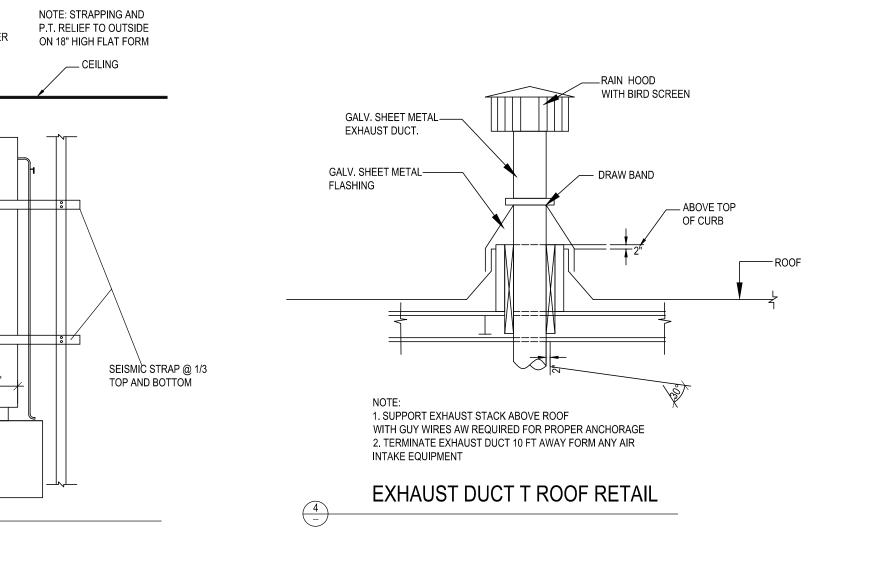


## **ELECTRICAL LEGENDS**

- ☼ CEILING RECEPTACLE OUTLET
- DUPLEX RECEPTACLE, MTD @ 12" U.O.N.
- → SINGLE OUTLET
- ⇒ 220V OUTLET
- WEATHERPROOF DUPLEX OUTLET W/GFGI GFI DUPLEX OUTLET W/GROUND
- FAULT INTERRUPTER DUPLEX RECEPTACLE, MTD@+12" U.O.N.
- SPLIT WIRE WITH HALF SW/CONTROLLED
- SPECIAL PURPOSE
- FLOOR DUPLEX RECEPTACLE OUTLET
- CARBON MONOXIDE SMOKE DETECTOR W/BATTERY BACK UP
- -O- CEILING LIGHT
- FLUORESCENT LIGHT
- RECESSED CANISTER
- FLOOR OUTLET (DBL)
- SWITCH \$3 3 WAY SWITCH
- \$4 4 WAY SWITCH
- DIMMER SWITCH
- \$T TIMER SWITCH
- CEILING FAN
  - → FUEL GAS
  - FAN TO OUTSIDE AIR
  - CARBON MONOXIDE SMOKE DETECTOR W/BATTERY BACK UP
  - INCANDESCENT LIGHT FIXTURE (CEILING)

  - WEATHERPROOF LIGHT FIXTURE
  - DISPOSAL
  - RECESSED LIGHT FIXTURE GreenBuilder Series 100 CFM Wall or Ceiling Bathroom Exhaust Fan with Adjustable Humidity Sensor,
- ENERGY STAR (MODEL GB100H) OOO CHIME

- GAS STUB
- HB HORSE BID WITH BACKFLOW PREVENTATION → DEVICE
- → HOSE BIBB SOV SHUT OFF VALVE
- BELL / BUZZER
- ELECTRICAL DISCONNECT
- DECORATIVE ABOVE MIRROR BATHROOM LIGHT SD CIRCUIT BREAKER
- ₩ KEY
- MOTION SENSOR
- CHANDELIER FLOOR SUPPLY AIR REGISTER
- CEILING SUPPLY AIR REGISTER
- FLOURESCENTLIGHT FIXUTE (SURFACE) SEE PLAN C CE CO DETECTORS U.L./SFM LISTED APPROVED

## LEGEND

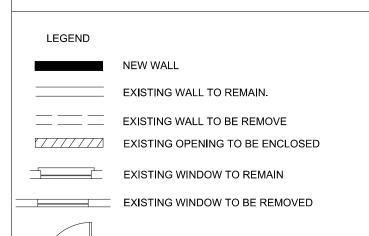

EXISTING DOORS TO REMAIN

STAMPED FROM CITY



Date: APRIL 2025

Drawn: LUYEN HONG NGUYEN

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Signed:


Email:helennguyen3689@gmail.com 9743 WHITE PINE WAY, ELK GROVE, CA 95624

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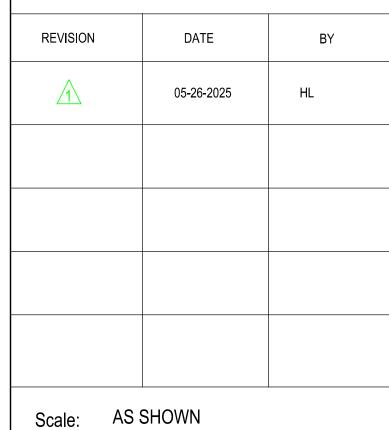
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## FLOOR PLAN NOTES:

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- 2. ALL LUMBER IN CONTACT WITH CONCRETE SHALL BE FOUNDATION GRADE RWD OR PRESSURE TREATED.
- 3. ALL LUMBER USED IN CONSTRUCTION LOCATED NEARER THAN 8" TO EARTH SHALL BE F.G. RWD OR P.T.
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- 5. PROVIDE FIRESTOPS @ CONCEALED DRAFT OPENING, CEILING LINES, FLOOR LINES, FURRED AREAS, SUSPENDED CEILINGS, STAIR STRINGERS, SHOWERS, CHIMNEY ENCLOSURES, & MID HEIGHT OF WALLS OVER 10' IN HEIGHT.
- 6. VERIFY MIN. 22"x30" FLOOR ACCESS. ATTIC ACCESS WITH 30" CLEARING ABOVE OPENING.
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- 10. MATERIAL GRADE STAMPS WILL BE CHECKED ON FRAME INSPECTION.
- 11. ALL CONSTRUCTION SHALL COMPLY WITH THE 2022 EDITION OF THE CBC, CMC, CPC, CEC, CRC AND CFC AND THE 2022 CALIFORNIA ENERGY CODE.
- 12. CHANGES FROM THE APPROVED PLANS DURING CONSTRUCTION OTHER THAN 1.) CABINET CHANGES WHEN NOT BEING SUPPORTED ENTIRELY BY THE ROOF STRUCTURE, APPROVED PLAN, 2.) INTERIOR NON-STRUCTURAL WALL FINISHES; SHALL CAUSE PLAN APPROVAL AND CONSTRUCTION TO BE SUSPENDED. A NEW PLAN CHECK (FOR A NEW PLAN) SHOWING CHANGES WILL BE SUBMITTED FOR REVIEW AND APPROVAL THROUGH THE NORMAL PLAN CHECK PROCESS.
- 13. FIREBLOCKING WITH NON-COMBUSTIBLE MATERIAL SHALL BE PROVIDED IN OPENINGS AROUND VENTS, PIPES, DUCTS, FIREPLACES, AND SIMILAR OPENINGS PER CBC 708.2.1 (4).
- 14. PROVIDE SMOKE DETECTORS (HARDWIRED 110v W/BATT BACK-UP) IN EVERY BEDROOMS, THE HALL WAY TO THE BEDROOM, PROVIDE CARBON MONOXIDE SMOKE ALARM DETECTOR IN ALL SLEEPING ROOM.
- 15. IN EACH NEW BEDROOM, THERE IS AT LEAST ONE WINDOW, FOR EMERGENCY ESCAPE OR RESCUE: REQUIRE OPENING OF MINIMUM NET CLEAR AREA, 5.7 SQ. FT. HEIGHT 24", WIDTH 20", AND MAXIMUM FINISHED OPENING HEIGHT 44"ABOVE FINNISH FLOOR
- 16. NEW 3'X3' MIN, CONCRETE LANDING AT ALL NEW EXTERIOR DOOR. LANDING SHALL NOT BE LOWER THAN 7-1/2" FROM FLOOR LEVEL.
- 17. BATHROOM SLIDING DOOR MUST BE TEMPERED GLASS.
- 18. ALL NEW BEDROOM MUST BE AFCI CIRCUIT.
- 19. PRESSURE OR THERMOSTATIC MIXING VALVE AT THE SHOWERS AND TUBS, WHICH LIMIT WATER TEMPERATURE TO 120 DEGREES F
- 20. THE SHOWERS MUST HAVE INSIDE DEMENSION OF AT LEAST 30 INCHES, THE TOTAL FLOOR AREA OF A SHOWER MUST BE AT LIST 1,024 SQUARE INCHES, OPENING TO SHOWER MUST BE MIN. 24 INCHES WIDE, THE DOOR MUST BE TEMPERED GLASS.(SEE DETAILS)

### ELECTRICAL NOTES:

### MOTION SENSOR WITH INTEGRAL PHOTOCONTROL

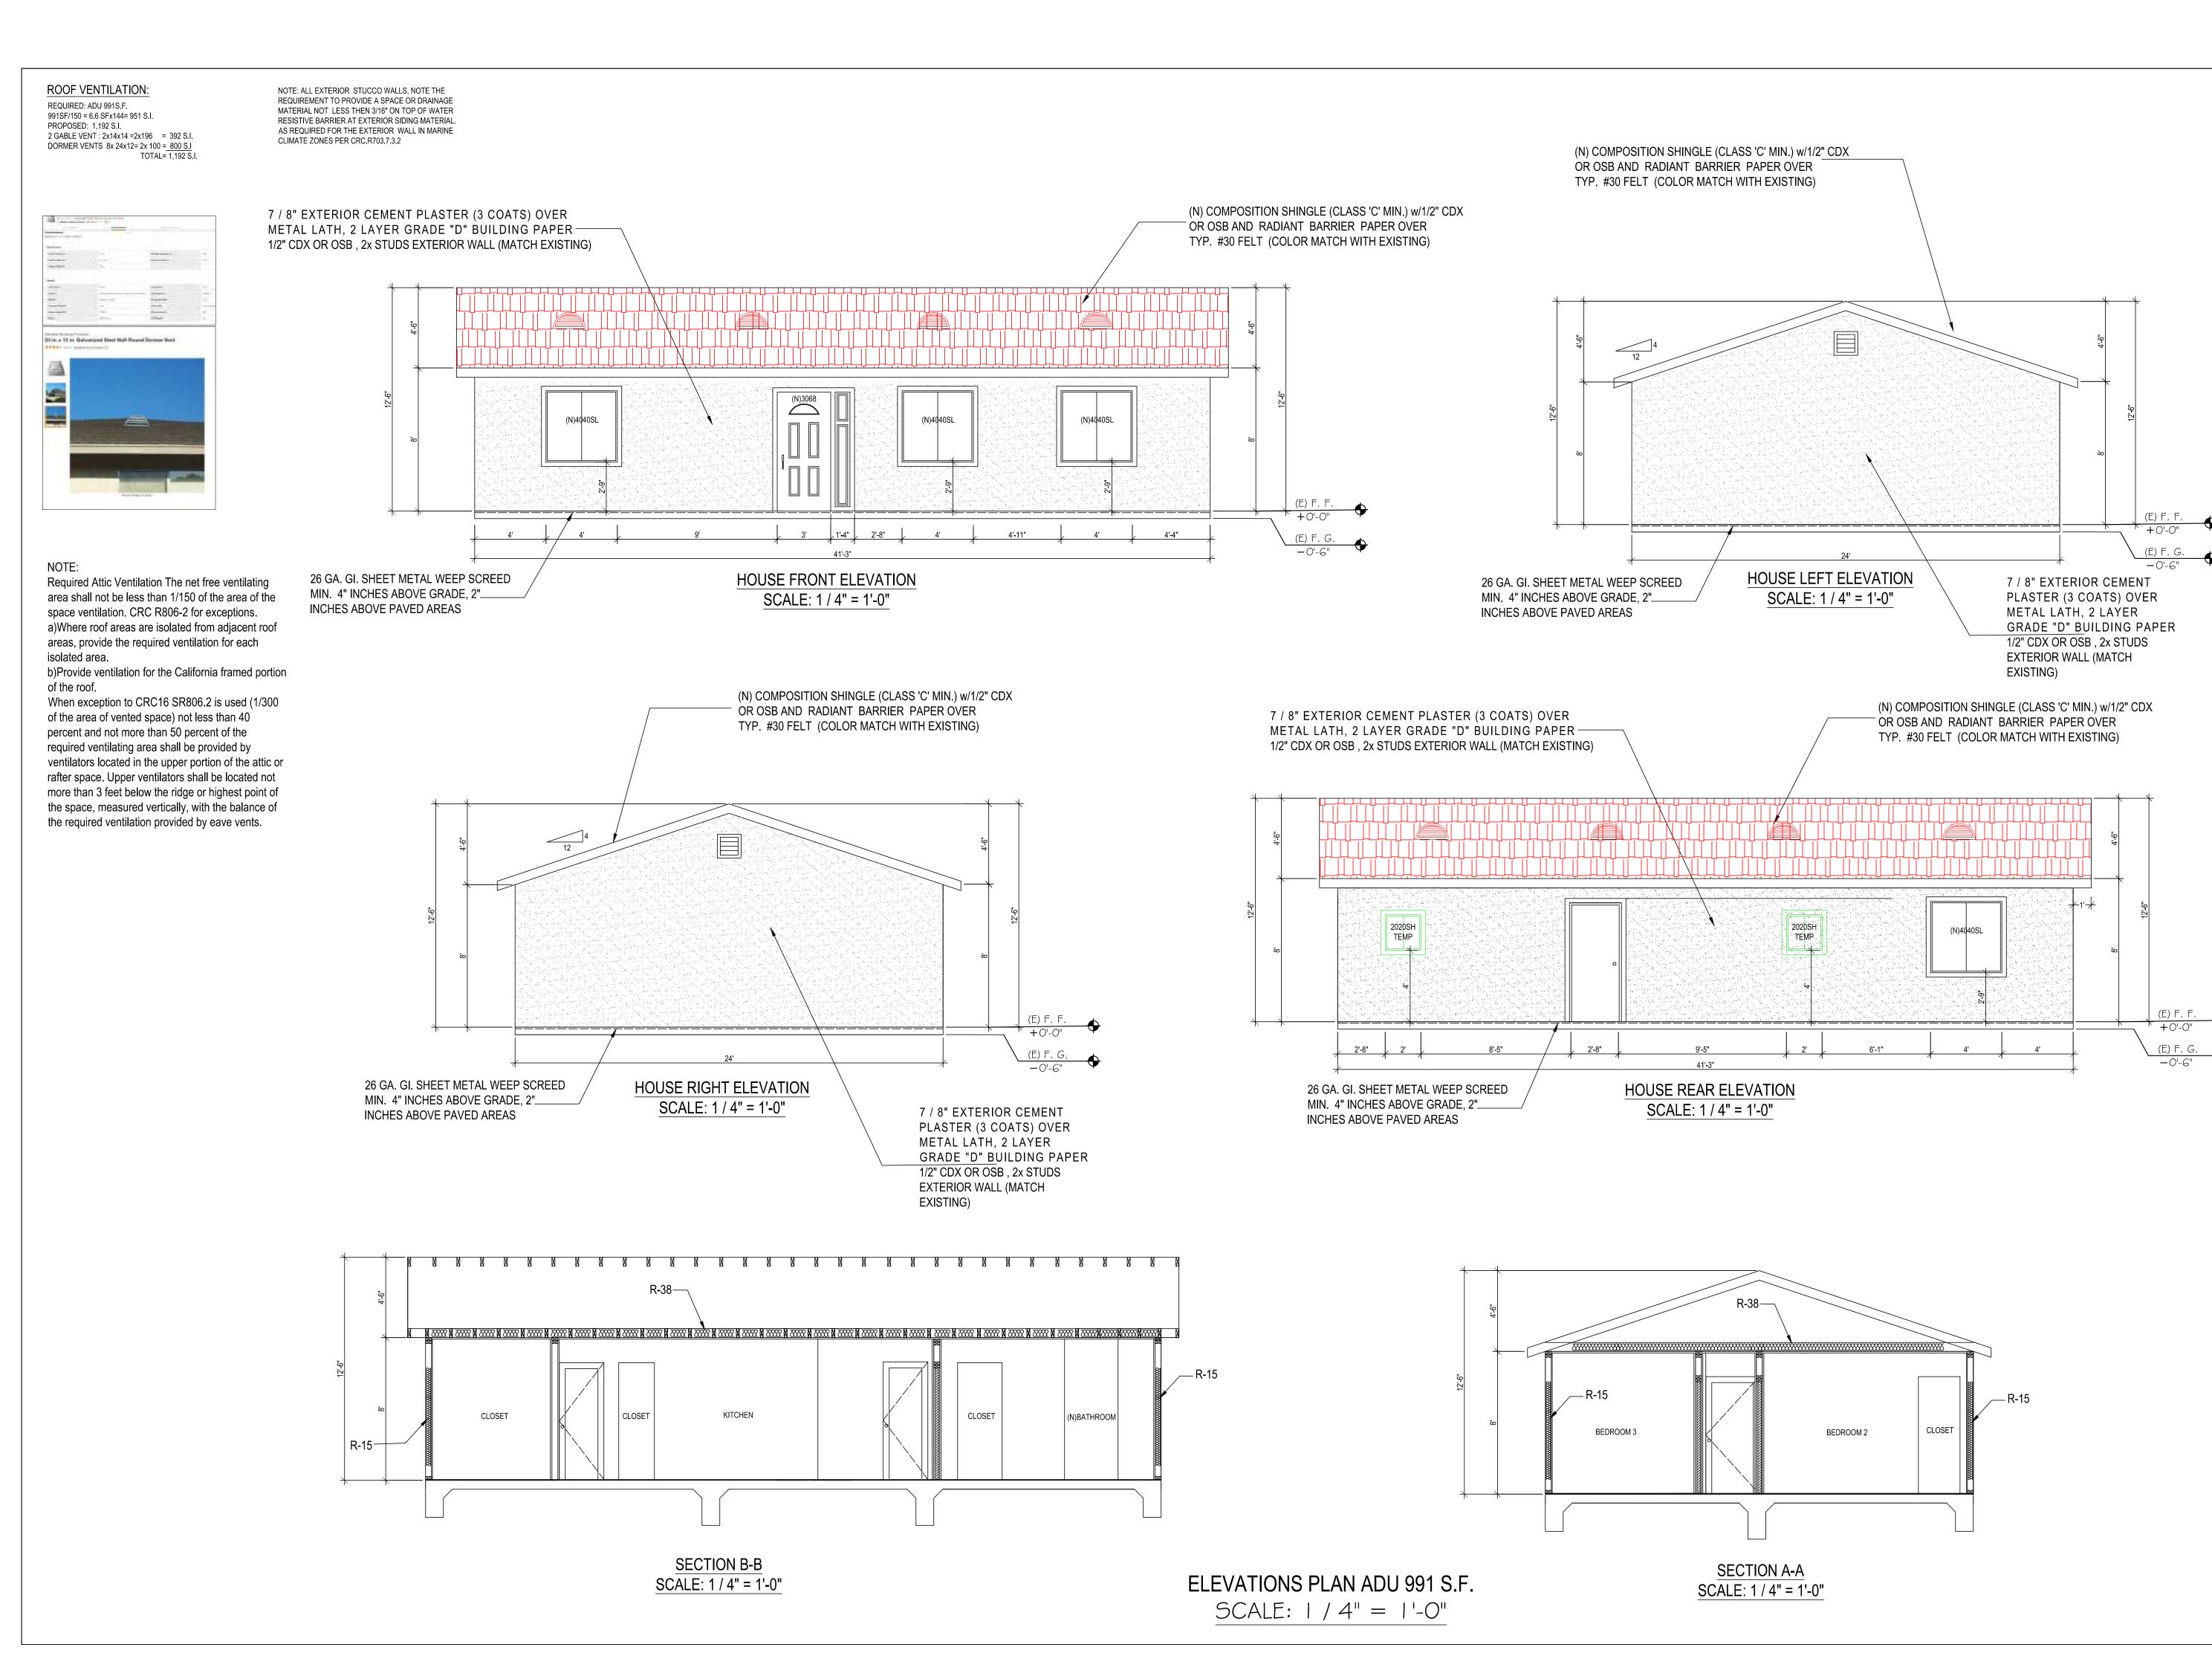- 2. ALL HARDWIRED LIGHTING IN BATHROOMS, GARAGES, LAUNDRY AND UTILITY ROOMS MUST BE HIGH EFFICACY CONTROLLED BY A MANUAL-ON MOTION SENSOR NEW LIGHTS MUST BE HIGH EFFICACY 2022 ENERGY CODE).
- 3. ALL HARDWIRED LIGHTING IN OTHER ROOMS (HALLWAYS, DINING ROOMS, FAMILY ROOMS AND BEDROOMS) SHALL BE HIGH EFFICACY CONTROLLED BY A MANUAL-ON OCCUPANT SENSOR A DIMMER MUST CONTROL IT
- 4. ALL SWITCHES ON A MULTIPLE SWITCHED CIRCUIT SHALL BE CONTROLLED BY THE DIMMER SWITCH ON THAT CIRCUIT
- 5. ALL RECESSED FIXTURES SHALL BE LABELED AS BEING CERTIFIED TO HAVE A LEAKAGE RATING OF LESS THAN 2.0 AT 75 PASCAL
- 6. ALL HIGH EFFICACY FIXTURES AND NON-HIGH EFFICACY FIXTURES SHALL BE SWITCHED SEPARATELY
- 7. SMOKE DETECTOR SYSTEM SHALL BE HARD-WIRED, INTERCONNECTED TO SOUND SIMULTANIOUSLY AND EQUIPED WITH BATTERY BACK UP.
- 8. MIN. 100% OF WATTAGE OF LIGHTS IN KITCHEN SHALL BE HIGH EFFICACY AND THOSE THAT ARE NOT SHALL BE SWITCHED SEPARATELY
- 9. LIGHTS MOUNTED TO EXTERIOR OF BUILDING SHALL BE HIGH EFFICACY OR ON A PHOTO CONTROL/MOTION SENSOR COMBINATION

LAMP POWER RATING:	MINIMUM LAMP EFFICACY:
15 watts or less	40 lumens per watt
over 15 watts to 40 watts	50 lumens per watt
over 40 watts	60 lumens per watt

## NOTES:

WATER-RESISTANT GYPSUM BACKING BOARD SHALL NOT BE USED WHERE THERE IN AREAS SUBJECT TO CONTINUOUS HIGH HUMIDITY . R702.3.7.1 USE CEMENTITIOUS BACKER BOARD OR EQUAL IN ALL WET LOCATIONS.

on plan the fire-resistance-rated floor/ceiling and wall assemblies shall extend to and be tight against the exterior wall, and wall assemblies shall extend from the foundation to the underside of the roof sheathing or rated floor/ceiling


Water Fixture Flow Rate Requirements (Water Conservation) Note: All plumbing fixtures must meet the ALL 120-VOLT, SINGLE PHASE, 15 AND 20 AMPERE maximum flow rates below to comply with California Plumbing Code (CPC) water conservation standards BRANCH CIRCUITS SUPPLYING OUTLETS INSTALLED IN 1. Toilet • Max flow rate: 1.28 GPF (Gallons per flush) • Code: CPC 403.2. PWELLING UNIT KITCHENS, FAMILY ROOMS. DINING 2. Kitchen Faucet • Max flow rate: 1.8 GPM (Gallons per minute) • Code: CPC 407.2.1 ROOMS' LIVING ROOMS' PARLORS, LIBRARIES, DENS 3. Residential Lavatory Faucet • Max flow rate: 1.2 GPM • Code: CPC 407.2.1, BEDROOMS, SUNROOMS, RECREATION ROOMS,

4. Shower Head • Max flow rate: 1.8 GPM • Code: CPC 408. CLOSETS, HALLWAYS, LAUNDRY AREAS, OR SIMILAR ROOMS OR AREAS SHALL BE PROTECTED BY A LISTED ARC-FAULT CIRCUIT INTERRUPTER, COMBINATION-TYPE, INSTALL TO PROVIDE PROTECTION NSP - Windows/Doors Maximum U-Factor 0.30, Maximum SHGC 0.23 for Zone 12 only. NFRC labels are required for OF THE BRANCH CIRCUIT.

1.USE 'DUROCK', WONDERBOARD', OR AN APPROVED EQUAL BEHIND GLUED-ON TILE IN TUB, BATH, OR SHOWER AREAS

2. SEPARATE SEWER LATERAL PERMIT AND INSPECTIONS

REQUIRED FROM DOT PRIOR TO CONNECTING.

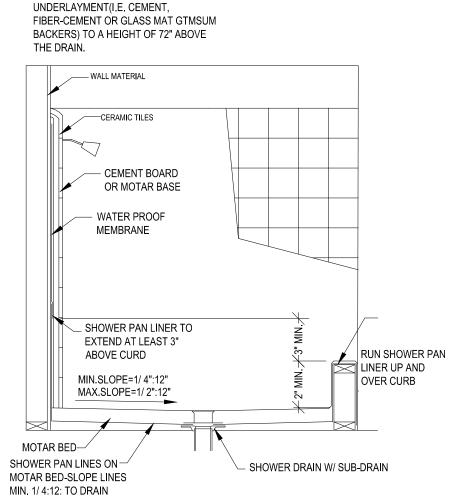

all windows & Doors.

30" TO FINISH

MIN. SHOWER INTERIOR CLEAR DIMENSION IS

BATHROOM DOOR MUST BE TEMPERED CLASS


SHOWER AND TUB/SHOWER WALLS TO

NONABSORBENT SURFACE(I.E. CERAMIC


TILES) OVER MOISTURE RESISTANT

SPECIFY A SMOOTH, HARD,

1,024 S.F. IN WITH NO DIMENSION LESS THAN

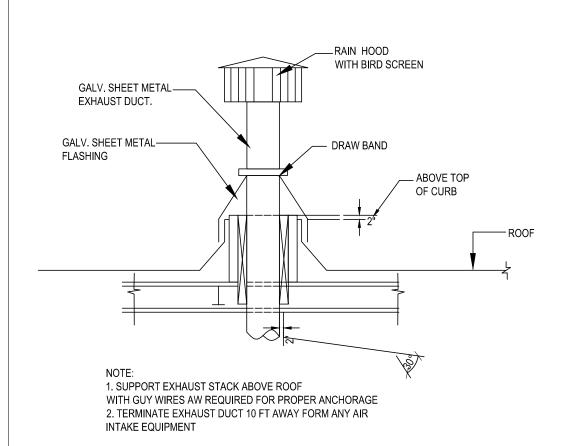



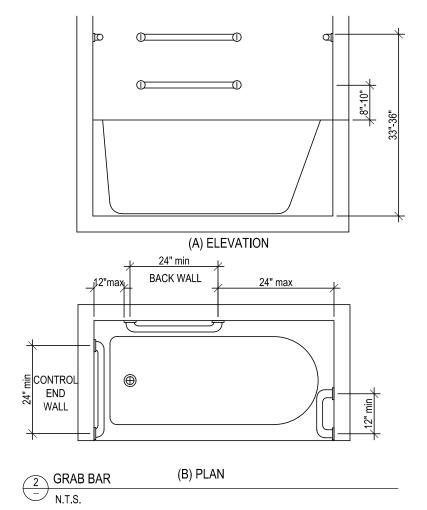

Aging-In Design note added For reinforcement installation: a) Reinforcement shall not be less than 2x8 nominal lumber or other construction material providing equal height and load capacity. Reinforcement shall be located between 32 inches and 39-1/4 inches above the finish floor flush with the wall framing.

c) Shower reinforcement shall be continuous where wall framing is provided. d) Bathtub and combination bathtub/shower reinforcement shall be continuous on each end of the bathtub and the back wall. Additionally, backwall reinforcement for a lower grab bar shall be provided with the bottom edge located no more than 6 inches above the bathtub rim.

b) Water closet reinforcement shall be installed on both side walls of the fixture, or one side wall and the back

3) On electrical plan: Receptacles, switches and controls (including controls for heating, ventilation and air conditioning) intended to be used byoccupants shall be located no more than 48 inches measured from the top of the outlet box and not less than 15 inches measured from the bottom of the outlet box above the finish box. 4) Doorbell buttons or controls, when installed, shall not exceed 48 inches above exterior floor or landing, measured from the top of the doorbell button assembly. Where doorbell buttons integrated with other features are required to be installed above 48 inches measured from the exterior floor or landing, a standard doorbell button or control shall also be provided at a height not exceeding 48 inches above exterior floor or landing, measured from the top of the doorbell button or control.

PROPOSAL FLOOR PLAN 749 SF SCALE: 1/4" = 1'-0"

MASTER BEDROOM

GRAB BAR 6'

MIN LENGTH,

GRAB BAR 6"

MIN LENGTH,

**DINING ROOM** 

OFFICE

This room is not intended for use

as a bedroom or sleeping area

(N)PLAYROOM

This room is not intended for use

as a bedroom or sleeping area

(N)KIT CHEN

MODEL#: JB645RKSS

SKU#: 1001763723

(N)DINING ROOM

(N)BEDROOM

(N)6040 WINDOW SL EGRESS

w/4X12 header

PROVIDE MIN. 10 MIL POLYETHYLENE

VAPOR RETARDER OR EQUIVALENT

Range Hood with Charcoal Filter

PANEL 125 AMPS

PANEL 125 AMPS

Item #841212 - Model #PV 7360SJS\$

(N) 3068 MAIN DOOI

w/4x12 HEADER

## ELECTRICAL LEGENDS

- ☼ CEILING RECEPTACLE OUTLET
- DUPLEX RECEPTACLE, MTD @ 12" U.O.N.
- ⇒ SINGLE OUTLET

NOTE: ALL ELECTRICAL RECEPTACLE OUTLETS,

CONTROLS FOR HEATING, VENTILATION.AND

OCCUPANTS SHALL BE LOCATED NOT MORE

THAN 48 INCHES MEASURED TO THE TOP OF

INCHES MEASURED TO THE BOTTOM OF THE

REQUIREMENTS. PLEASE SEE SECTION FOR

OUTLET BOX AND ABOVE THE FINNISH FLOOR

THE OUTLET BOX AND NOT LESS THAN 15

PER SECTION R327.1.2 AGING IN PLACE

EXCEPTIONS TO THESE REQUIREMNTS

BEDROOM 2

BEDROOM 3

LIVING ROOM

(E) MAIN DOOR

AIR CONDITIONING) INTENDED TO BE USED BY

SWITCH, AND CONTROLS (INCLUDING

- ⇒ 220V OUTLET
- ⊕G WEATHERPROOF DUPLEX OUTLET W/GFGI
- GFI DUPLEX OUTLET W/GROUND FAULT INTERRUPTER
- DUPLEX RECEPTACLE, MTD@+12" U.O.N.
- SPLIT WIRE WITH HALF SW/CONTROLLED
- SPECIAL PURPOSE FLOOR DUPLEX RECEPTACLE OUTLET
- CARBON MONOXIDE SMOKE DETECTOR W/BATTERY BACK UP
- -○- CEILING LIGHT


- RECESSED CANISTER
- \$ SWITCH
- \$3 WAY SWITCH
- DIMMER SWITCH

\$<sub>4</sub> 4 WAY SWITCH

- \$T TIMER SWITCH
- CEILING FAN
- → FUEL GAS
- FAN TO OUTSIDE AIR
- CARBON MONOXIDE SMOKE DETECTOR W/BATTERY BACK UP
- INCANDESCENT LIGHT FIXTURE (CEILING)


- PUSH BUTTON
- ⊢ G GAS RISER
- HB HORSE BID WITH BACKFLOW PREVENTATION → DEVICE
- ⊢ HOSE BIBB SOV SHUT OFF VALVE
- OCO DECORATIVE ABOVE MIRROR BATHROOM LIGHT
- SD CIRCUIT BREAKER
- ₩ KEY
- CHANDELIER
- CEILING SUPPLY AIR REGISTER
- C CE CO DETECTORS U.L./SFM LISTED APPROVED

## LEGEND

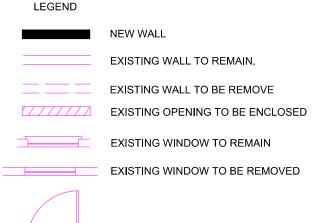

EXISTING DOORS TO REMAIN

STAMPED FROM CITY

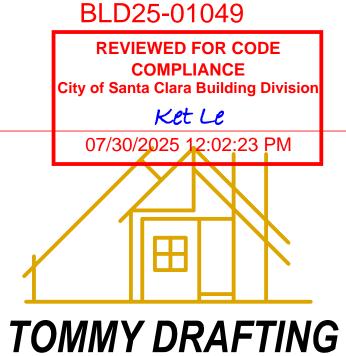

Date: APRIL 2025

Drawn: LUYEN HONG NGUYEN

(916) 526-5881 (408) 876-8402

Signed:

ELEC

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OOR

Email:helennguyen3689@gmail.com 9743 WHITE PINE WAY, ELK GROVE, CA 95624

WEATHERPROOF LIGHT FIXTURE

DISPOSAL

RECESSED LIGHT FIXTURE

GreenBuilder Series 100 CFM Wall or Ceiling Bathroom Exhaust Fan with Adjustable Humidity Sensor, ENERGY STAR (MODEL GB100H)

O O O CHIME

○ BELL / BUZZER

ELECTRICAL DISCONNECT

MOTION SENSOR


FLOOR SUPPLY AIR REGISTER

➡ FLOURESCENTLIGHT FIXUTE (SURFACE) SEE PLAN

Scale: AS SHOWN

SHEET NO:

PROPOS/ REVISION 05-26-2025 HL

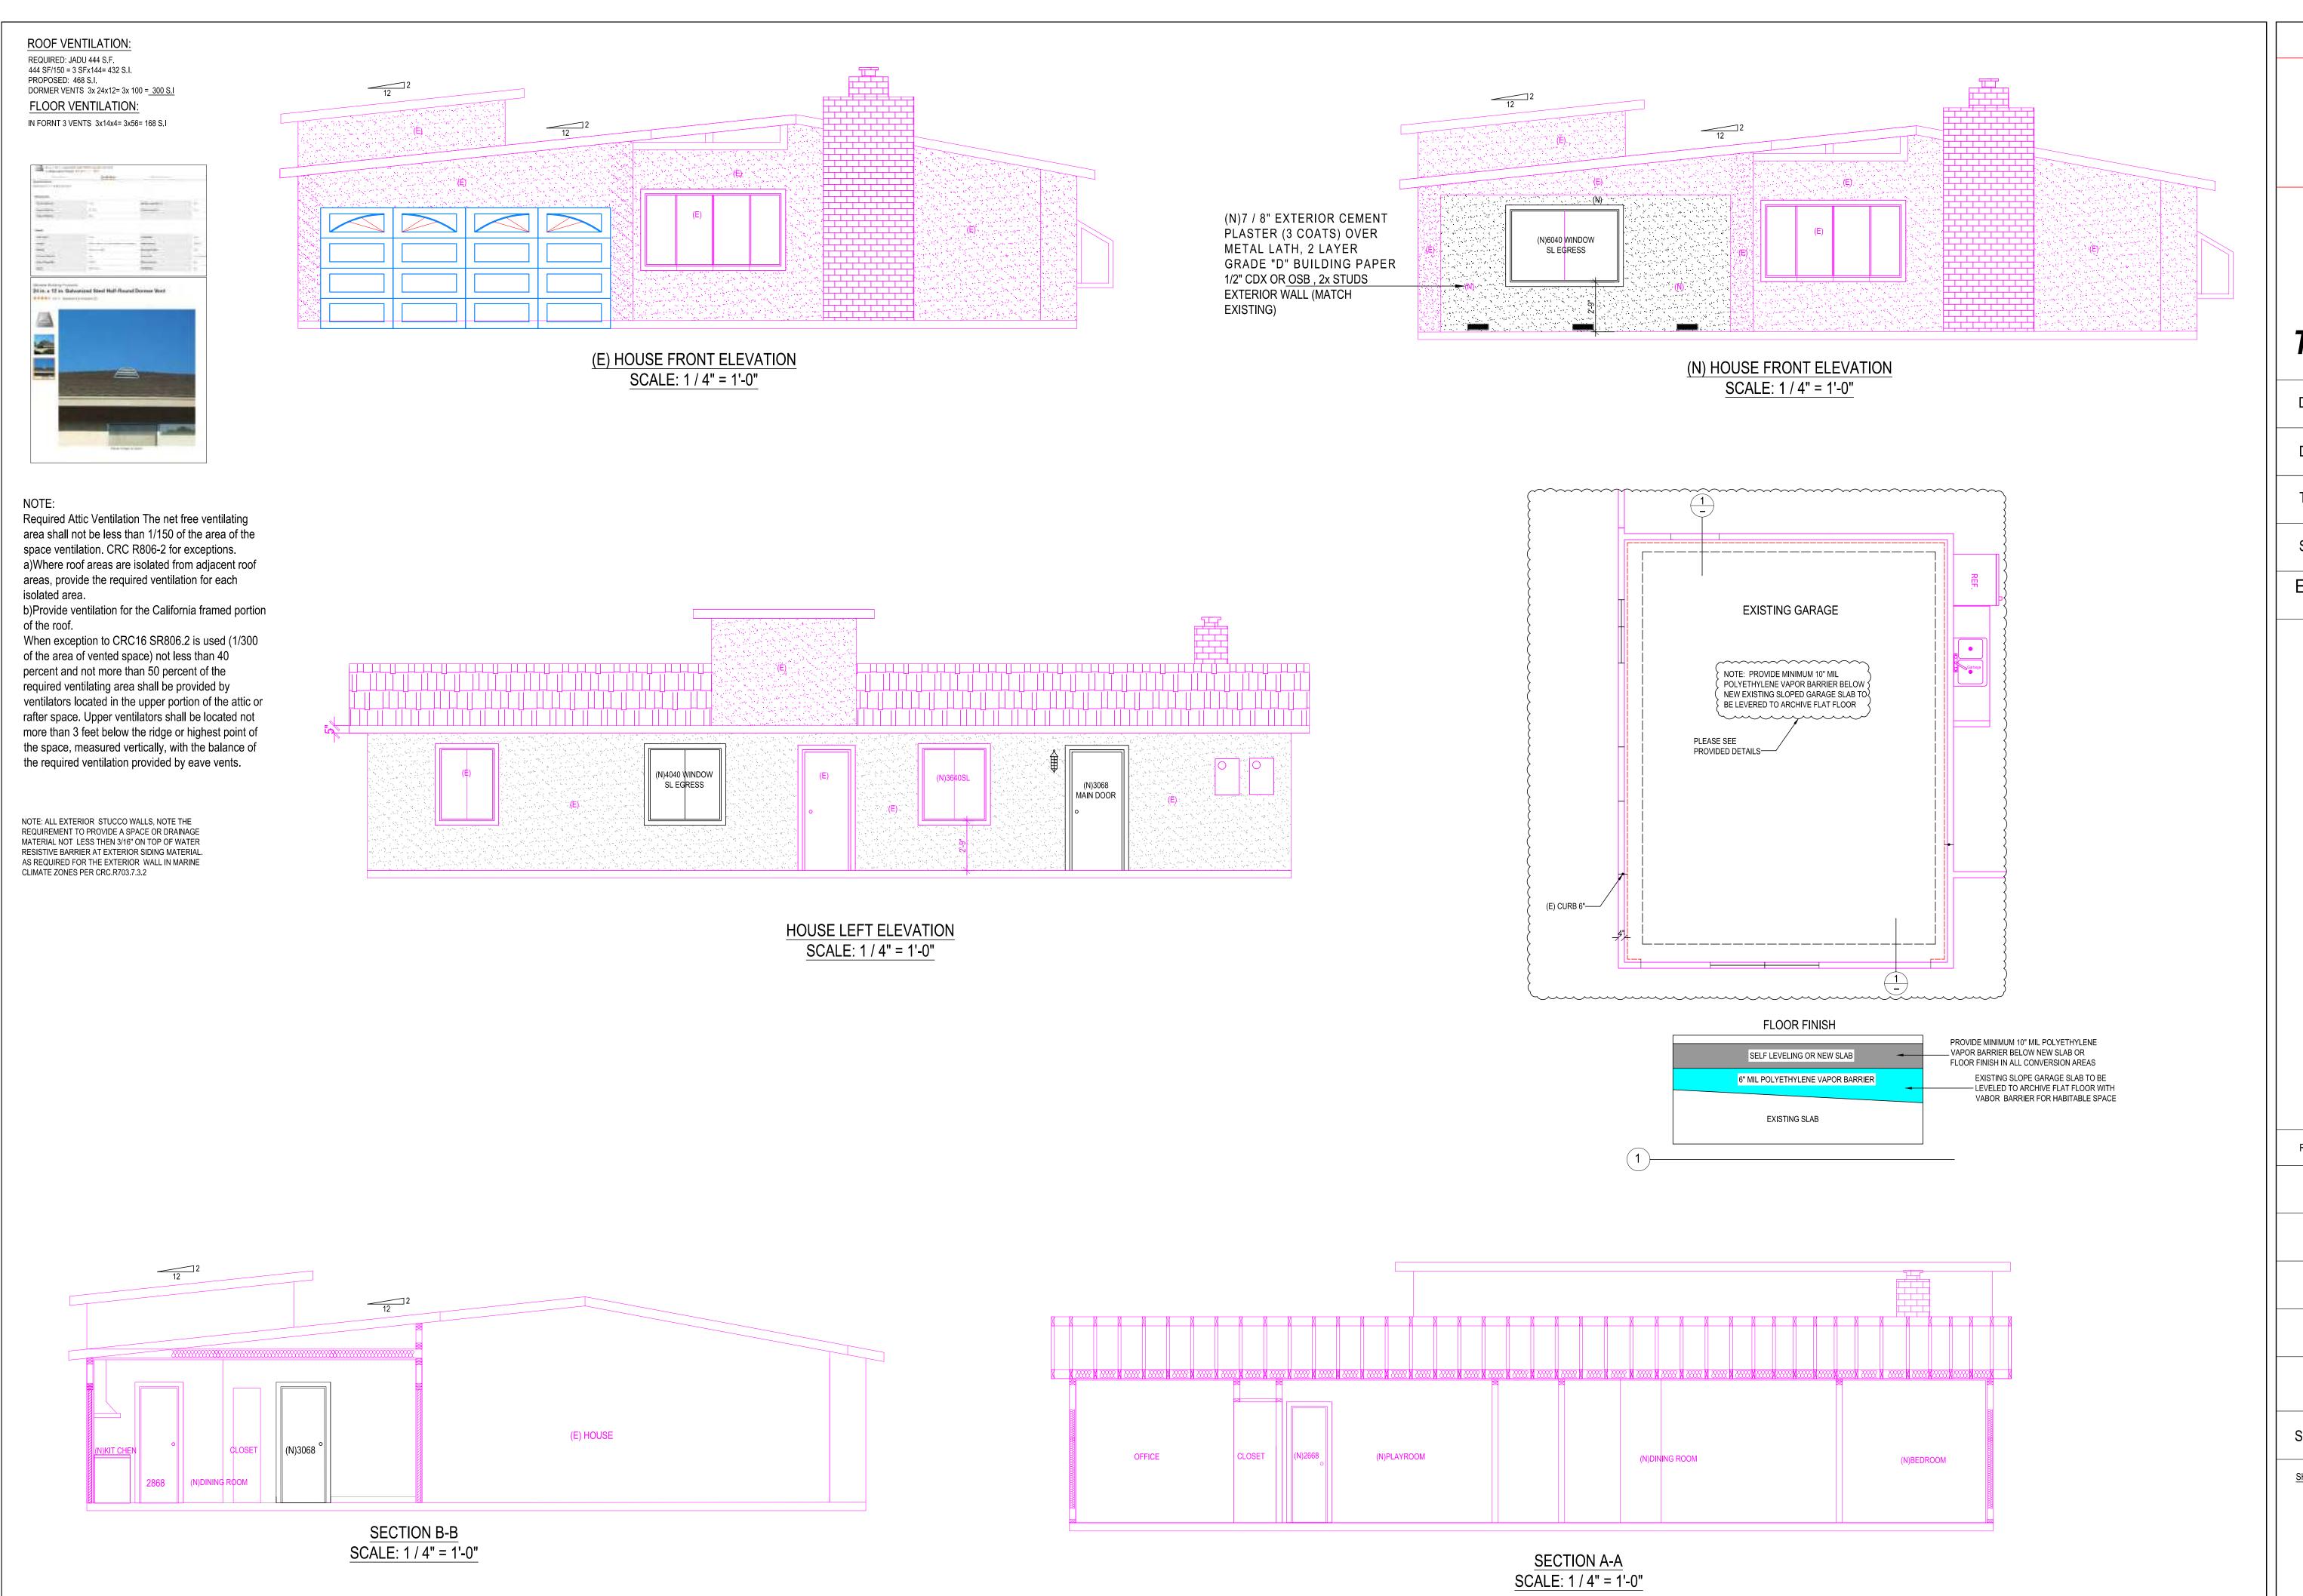

STAMPED FROM CITY

BLD25-01049

REVIEWED FOR CODE
COMPLIANCE
City of Santa Clara Building Division
Ket Le
07/30/2025 12:02:23 PM

TOMMY DRAFTING

Date: APRIL 2025

Drawn: LUYEN HONG NGUYEN

(916) 526-5881 (408) 876-8402

Signed: Thuy

Email:helennguyen3689@gmail.com

9743 WHITE PINE WAY, ELK GROVE, CA 95624

ELEVATION PLANS FOR JADU
1340 VIA DONDERA
SANTA CLARA, CA 9505

REVISION	DATE	ВУ
$\triangle$	05-26-2025	HL

Scale: AS SHOWN

SHEET NO:

**A-9**