LOU & CHAU DAM'S RESIDENCE

2075 CUNNINGHAM AVE, SAN JOSE, CA 95122

ELECTRIC

4'-11"

SMOKE ALARMS – CRC 314

OUTSIDE EACH SEPARATE SLEEPING AREA IN THE

IMMEDIATE VICINITY OF THE BEDROOMS; AND ON EACH

ADDITIONAL STORY OF THE DWELLING INCLUDING

BASEMENTS AND HABITABLE ATTICS

CARBON MONOXIDE ALARMS – CRC 315

INSTALL CO ALARMS OUTSIDE OF EACH SEPARATE

DWELLING UNIT SLEEPING AREA IN THE IMMEDIATE

VICINITY OF THE BEDROOMS; AND ON EVERY LEVEL OF

THE DWELLING UNIT, INCLUDING BASEMENTS

INSTALL SMOKE ALARMS IN EACH SLEEPING ROOM:

METER

STRUCTURAL GENERAL NOTES

A. GENERAL

- 1. ALL WORK SHALL CONFORM TO CURRENT 2022 CBC, CBC, CMC, CPC, 2022 NEC, 2022 CEC.LAWS & ORDINENCES
- 2. THE CONTRACTOR SHALL VERIFY & BE RESPONSIBLE FOR ALL DIMENTIONS & CONDITIONS AT THE JOB SITE AND SHALL NOTIFY CONDITIONS & WHAT IS SHOWN ON THE DRAWINGS BEFORE PROCEDING WITH THE WORK
- 3. ANY OMISSIONS OR CONFLICTS BETWEEN THE ARCHITECTURAL STRUCTURAL & MECHANICAL DRAWINGS SHALL BE BROUGHT TO THE ATTENTION OF THE CITY INSPECTOR.
- 4. SHOP DRAWINGS REQUIRED BY THE SPECIFICATIONS SHALL BE SUBMITTED TO THE ARCHITECT PRIOR TO FABRICATION, & ALLOW REASONABLE TIME FOR REVIEW AND APPROVAL BY THE STRUCTURAL
- 5. THE CONTRACTOR SHALL BE RESPONSIBLE FOR THE SAFTEY OF THE BUILDING DURING THE CONSTRUCTION. THE CONTRACTOR SHALL PROVIDE ADEQUATE SHORING, BRACING & GUYS IN ACCORDANCE WITH ALL NATIONAL, STATE AND LOCAL SAFETY ORDANCES. ANY DEVIATIONS MUST BE APPROVED PRIOR TO ERECTION.
- 6. ALL CONDITIONS NOT CLEARLY SHOWN OR DETAILED SHALL BE OF THE SAME TYPE & CHARACTER AS THOSE SHOWN FOR SIMILAR CONDITIONS.

B. FOUNDATION

1. FOUNDATION EXCAVATIONS SHALL BE FREE OF LOOSE MATERIAL PRIOR TO THE PLACEMENT OF ANY REINFORCING STEEL OR CONCRETE.

C. CONCRETE

- 1. ALL CONCRETE SHALL HAVE A MINIMUM COMPRESSIVE STRENGTH OF 2500 PSI AT 28 DAYS.
- 2. CONCRETE SHALL BE REGULAR WEIGHT HARD ROCK TYPE(150#CF) & AGREGATE SHALL CONFORM TO ASTM C33 U.O.N.
- 3. CEMENT SHALL CONFORM TO ASTM C150, TYPE 1 OR 2.
- 4. PLACEMENT OF CONCRETE SHALL BE IN CONFORMANCE WITH ACI 301
- 5. CONCRETE SHALL BE MACHINE MIXED AND DELIVERED IN ACCORDANCE WITH ASTM C-94. SUBMIT MIX DESIGN TO THE ARCHITECT FOR APPROVAL PRIOR TO PLACING CONCRETE.
- 6. PROVIDE MINIMUM CLEAR COVER OF CONCRETE OVER REINFORCING AS FOLLOWS

D. REINFORCING STEEL

- 1. ALL REINFORCING STEEL SHALL CONFORM TO ASTM SPECIFICATION A615 GRADE 60 FOR #5 AND LARGER BARS AND GRADE 40 FOR #3 & #4.
- 2. ALL REINFORCING STEEL SHALL BE LAPPED AS NOTED BELOW, #4: 24" FOR BOTTOM BARS AND 28" FOR TOP BARS; #5: 30" FOR BOTTOM BARS AND 35" FOR TOP BARS; #6: 40" FOR BOTTOM BARS AND 46" FOR TOP BARS AT SPLICES UNLESS OTHERWISE NOTED ON
- PLANS. SPLICES SHALL BE LOCATED AS DETERMINED IN THE PLANS. STAGGER ALL LAPS SPLICES.
- 3. WELDED WIRE FABRIC SHALL CONFORM TO ASTM A82 AND A185.
- 4. ANCHOR BOLTS, DOWELS AND OTHER EMBEDDED ITEMS SHALL BE SECURELY TIED IN PLACE BEFORE CONCRETE IS PLACED, USE CYT THREAD ANCHOR BOLTS ONLY.

E. STRUCTURAL & MISC. STEEL

- 1. FABRICATION AND ERECTION TO BE IN ACCORDANCE WITH LATEST AISC SPECIFICATIONS. STRUCTURAL STEEL SHALL BE ASTM A36, EXCEPT TUBE COLUMNS WHICH ARE ASTM A500, GRADE B.
- 2. WELDING TO BE IN ACCORDANCE WITH AWS SPECIFICATIONS. WELDING SHALL BE PERFORMED BY CERTIFIED WELDERS USING E77XX ELECTRODES.
- 3. ALL PLATES, ETC., TO BE BOLTED TO CONCRETE ELEMENTS, SHALL NOT BE FABRICATED UNTIL THE BOLTS HAVE BEEN LOCATED IN THE
- 4. BOLTS SHALL BE ASTM A307 TYPE. THREADS MAY BE INCLUDED IN THE SHEAR PLANES
- 5. STEEL TO BE SHOP PRIMED FOR, EXCEPT WHERE EMBEDDED IN CONCRETE OR TO BE WELDED.
- 6. ALL WELDING SHALL BE CONTINUOUSLY INSPECTED BY AN INDEPENDENT INSPECTOR APPROVED BY THE BUILDING DEPARTMENT.

F. WOOD FRAME CONSTRUCTION

- 1. GENERAL WOOD FRAMING: WOOD FRAMING THROUGHOUT THE BUILDING SHALL BE CONSTRUCTED IN ACCORDANCE WITH CALIFORNIA BUILDING CODE (2019) AND THE STANDARD PRACTICES RECOMENDED BY AMERICAN INSTITUTE OF TIMBER CONSTRUCTION AND WCLA GRADING. FOR NAILING SEE SECTION J. BOLTS IN WOOD FRAMING SHALL BE STANDARD MACHINE BOLTS WITH STANDARD MALLEABLE IRON WASHERS
- 3. WOOD PLATES: BEARING DIRECTLY UPON CONCRETE SHALL BE P.T.D.F.
- 4. UNLESS OTHERWISE NOTED ON DRAWINGS OR IN SPECIFICATIONS, FRAMING MEMBERS SHALL HAVE THE FOLLOWING GRADING:

CITY OF SAN JOSE BUILDING DIVISION PROJECT INFORMATION Address 2075 Cunningham Ave, San Jose, CA 95122 Unit 2

(E) FAMILY ROOM & (E) BATHROOM

TO BE JADU 377 S.F

(E) GARAGE

DRIVE WAY

(E) BATHROOM

CODE EDITIONS: CBC, CRC, CPC, CMC, CEC, CGC, CEC 2019 OCCUPANCY GROUP(S) TYPE OF CONSTRUCTION V-B

Unit 2

BEPM #23-096044 A SITE VISIT.

(E) HOUSE

Reviewed for Code Compliance City of San Jose, Building Division **☒** Building ☐ Electrical

☐ Plumbing ☐ Mechanical Kiet Pham (408) 535-7773 **No.** 23-096044 **Date:** 5/24/2023

(408) 535-3555 FOR REFERRAL TO SPECIALTY TRADE SUPERVISOR(S), IF YOU HAVE QUESTIONS OR WOULD LIKE TO SCHEDULE

OWNER: LOU & CHAU DAM'S RESIDENCE **EXISTING USE:** SINGLE FAMILY RESIDENCE LOCATION: 2075 CUNNINGHAM AVE. SAN JOSE. CA 95122 APN: ZONING: LOT GROSS SIZE: 4,791 S.F. OCCUPANCY GROUP: TYPE OF CONSTRUCTION: NONE FIRE SPRINKLER: 1965 ALLOWABLE FLOOR AREA: 2,156 S.F LOT AVERAGE SLOPE: (FLAT) EXISTING PROPOSAL FLOOR AREA: 1,856 S.F GARAGE: 362 S.F dult Center TOTAL FOOTPRINT: 1,856 S.F 38.7% SCOPE OF WORK (E) FAMILY ROOM AND (E) BATHROOM 377 S.F CONVERT TO BE JADU (INCLUDED: NEW 1 BEDROOM, (E) 1 BATHROOM AND NEW 1 KITCHEN). BUILD NEW INTERIOR WALL 104 S.F. THE ROOF AND ELEVATION TO REMAIN 52 51 50 49 48 47 46 45 44 ² 43 ² **9** 70 69 **8** TRACT No. 2889 STRUCTURAL GENERAL NOTES SHEET IN DEX

G. NAIL SCHEDULE

1. WOOD MEMBERS SHALL BE CONNECTED WITH NAILING INDICATED IN TABLE 2304.9.1 OF 2022 CBC UNLESS GREATER SIZES AND NUMBER OF NAILS ARE SHOWN OR NOTED ON DRAWINGS; NAILS EXPOSED TO WEATHER SHALL BE GALVANIZED; NAILS SHALL BE COMMON WIRE NAILS; HOLES FOR NAILS SHALL BE PROVIDED WHERE THE WOOD TENDS TO SPLIT; SPLIT WOOD MEMBERS SHOULD BE REPLACED AND REMOVED FROM THE JOB PROMPTLY. SHORT PLYWOOD NAILS FOR EQUIVALENT SHEAR VALUE MAY BE USED. SEE PLANS FOR NAIL SPACING. NAIL ROOF SHEATHING 8d @ 6" O.C. AT SUPPORTED EDGES. 8d @ 10 INCHES O.C. AT INTERMEDIATE SUPPOERTS. FLOOR SHEATHING 8d @ 6" O.C. AT BOUNDARIES AND PANEL EDGES AND 8d @ 10" O.C. AT INTERMEDIATE SUPPORTS. PLYWOOD WALL SHEATHING SHALL BE NAILED PER SHEAR WALL SCHEDULE AT SHEAR WALLLS, AND AT A MINIMUM OF 8d @ 6" O.C. ALL OTHER

PROJECT DATA

2. AT PRESSURE TREATED LUMBER USE HOT-DIPPED GALVANIZED, STAINLESS STEEL, SILICON BRONZE, OR COPPER.

ALL CONSTRUCTION SITES MUST COMPLY WITH APPLICABLE PROVISION

OFF THE CFC CHAPTER 14 AND OUR STANDARD DETAIL AND SPECIFICATION SI-7

APPLICABLE CODES

G. FIRE SPRINKES

-2022 CA ENERGY CODE

-CITY OF SAN JOSE MUNICIPAL CODE -ALL LOCAL ORDINANCES

SITE PLAN, SUMMARY, NOTES, AREA

ARCHITECTURE

VICINITY MAP

- PROPOSAL FLOOR AND ELECTRIC PLAN
- ELEVATIONS PLANS AND INSPECTOR CHECKLIST **FOUNDATION & ROOF DETAILS**
- T-24 ENERGY REPORT
- CG-1 CAL GREEN MANDATORY
- CG-2 CAL GREEN MANDATORY

NOTES

CODE COMPLIANCE

ALL CONSTRUCTION SHALL CONFORM TO ALL GOVERNING LAWS, CODES AND ORDINANCES INCLUDING BUT NOT LIMITED TO THE FOLLOWING: -2022 CALIFORNIA BUILDING CODES: CBC, CMC, CPC, CFC & CEC, CRC.

a) Please note that a Building Permit cannot be issued until all clearances by all reviewing departments (listed above) have been approved on the project. Check the status of your permit by visiting www.sjpermits.org and contact the individual departments directly with any

b) Revised plans, when required, must be clouded with delta number with a revision mark at each location where revision has occurred and be noted that additional comments may be triggered once revised plan are reviewed.

c)When comments cite a section of code and require a revision, correction or amendment to plans, required information shall be specifically & directly provided on plans. Generic references to code section(s) is not acceptable.

1449 BOB WHITE PLACE, SAN JOSE, CA 9513 Emails: william t55@yahoo.com helennguyen3689@gmail.com Tel: (408) 876-8402 (916) 526-5881


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REVISION	BY
Date: APRIL 2023	
Scale: AS SHOWN	
Drawn: WILLIAM TRAN & LUYEN HONG NGUYEN	
Signed: Thuy	
SHEET NO:	



SITE PLAN - SCALE: 1 / 8" = 1'-0"

PROPERTY LINE 50.0

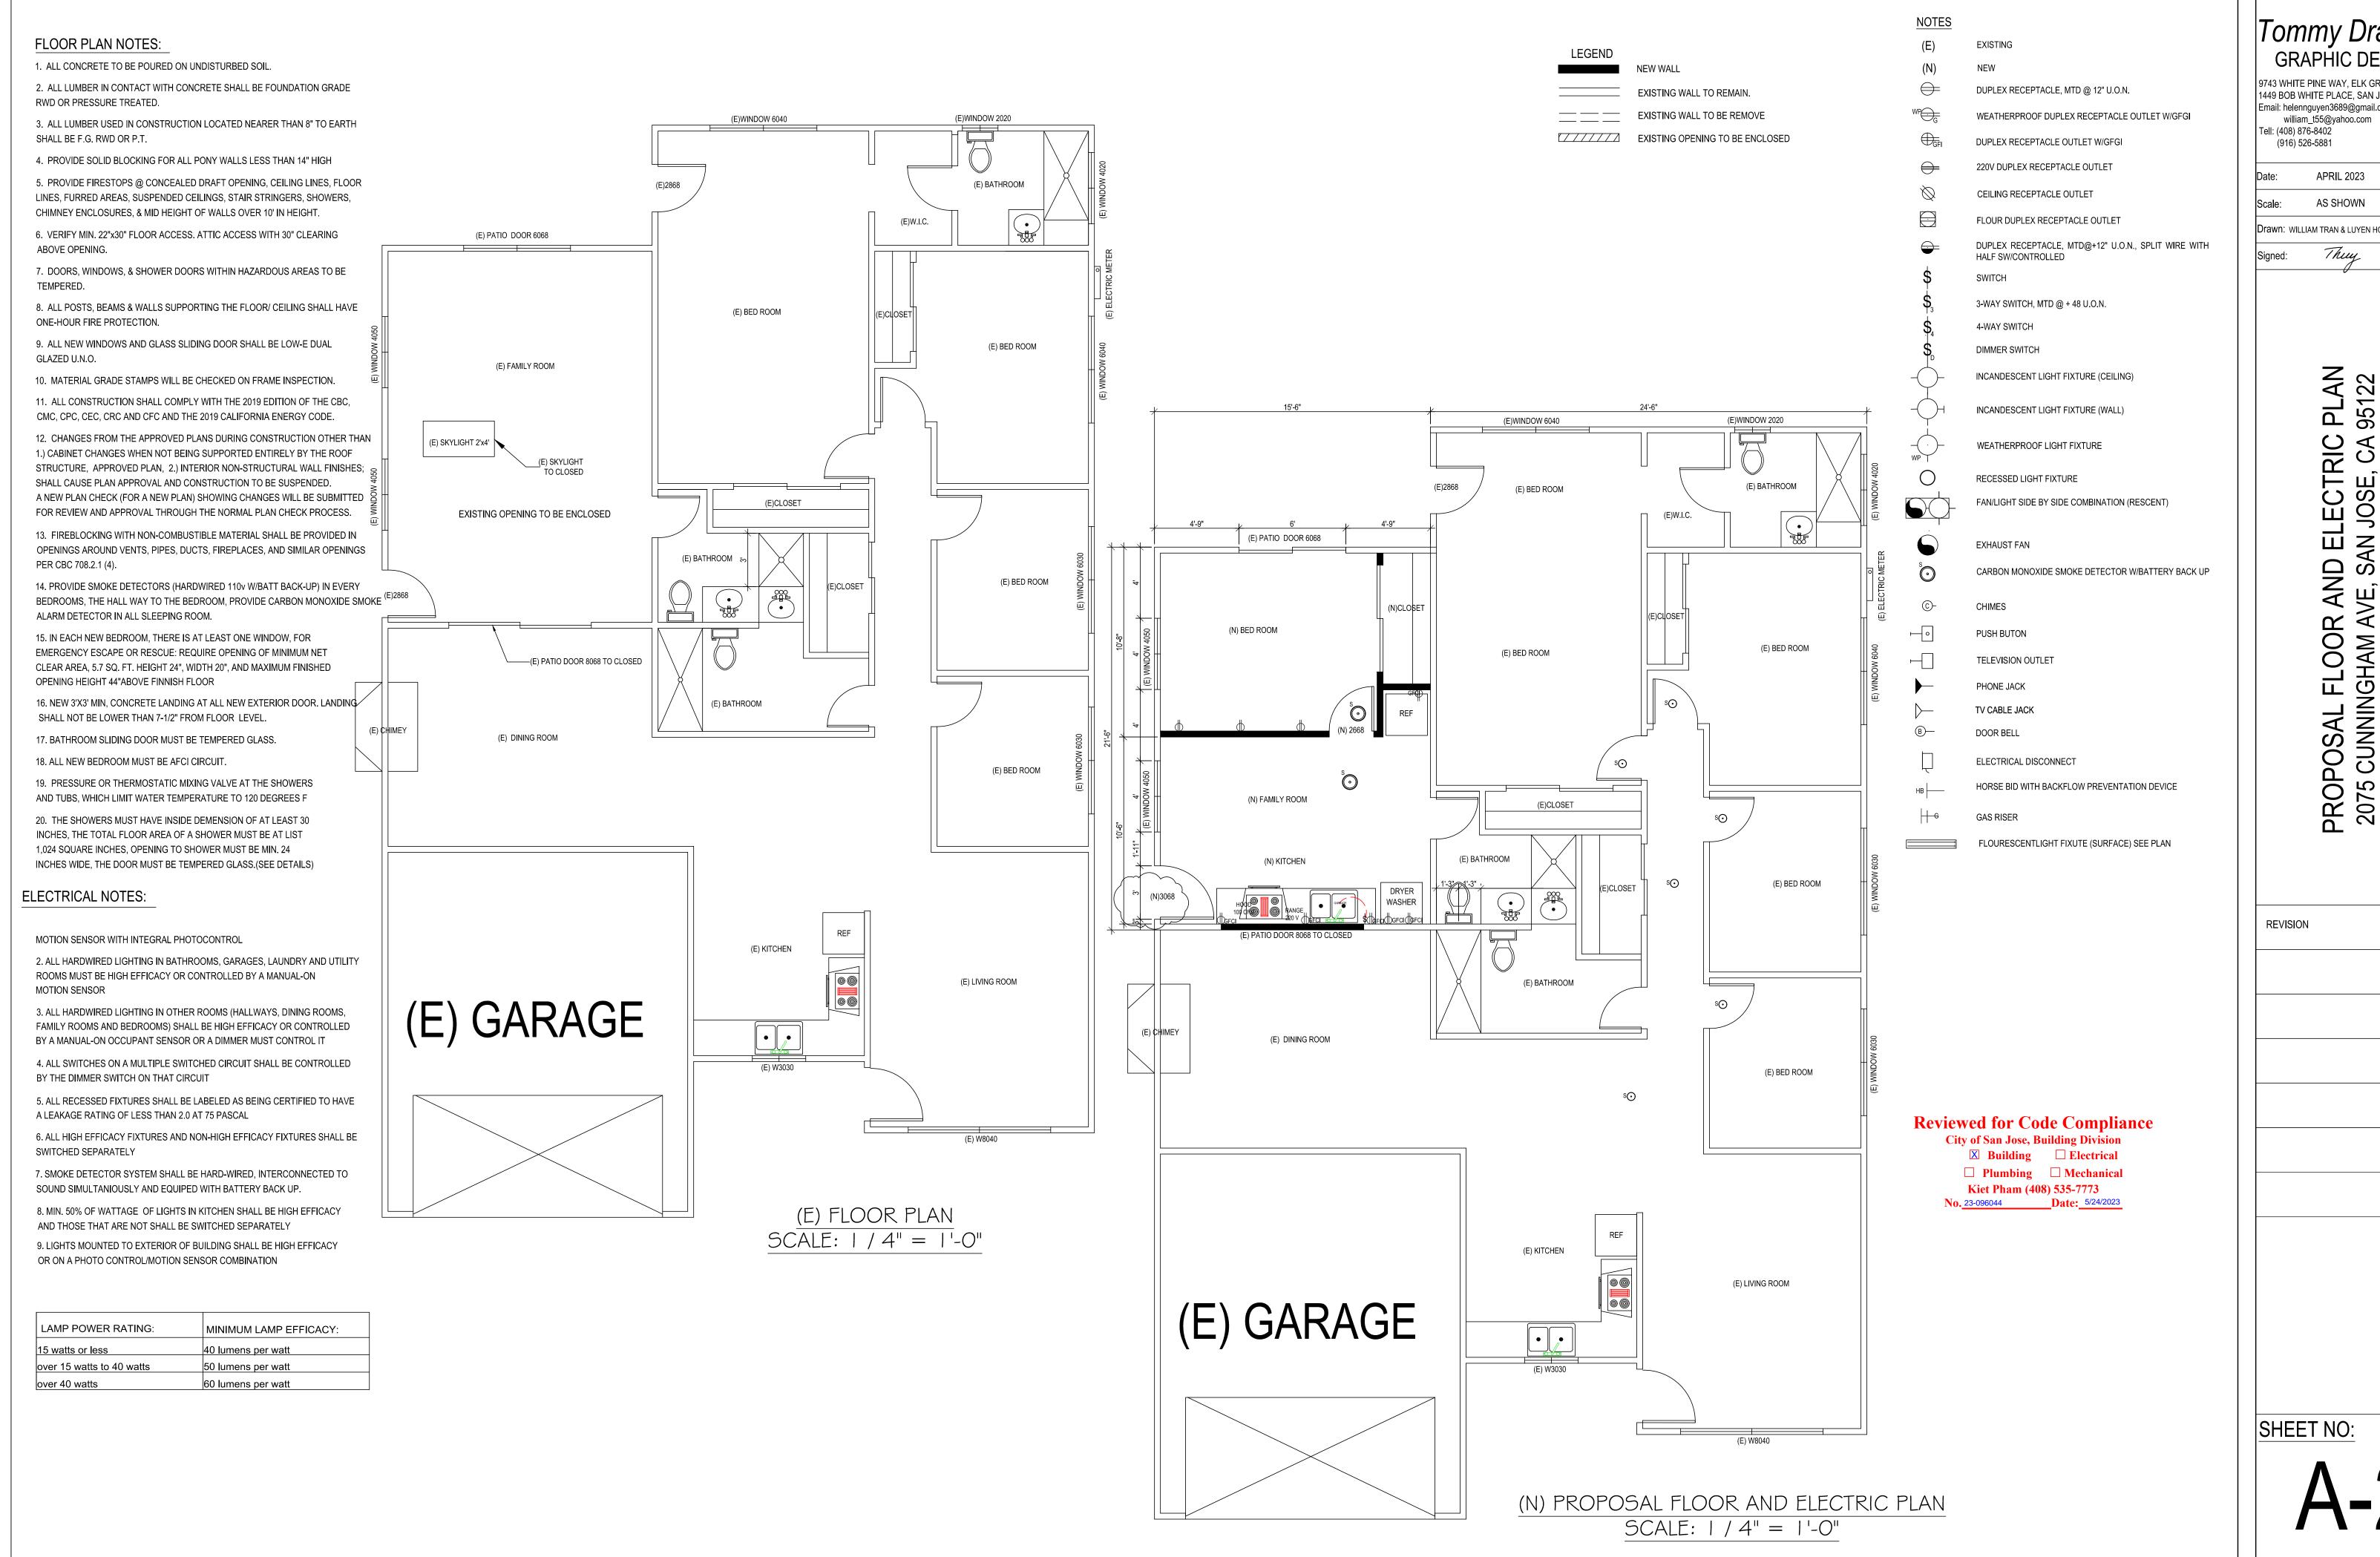

Tommy Drafting GRAPHIC DESIGN

9743 WHITE PINE WAY, ELK GROVE, CA 95624 1449 BOB WHITE PLACE, SAN JOSE, CA 95131 Email: helennguyen3689@gmail.com william_t55@yahoo.com Tell: (408) 876-8402

> APRIL 2023 AS SHOWN

Drawn: WILLIAM TRAN & LUYEN HONG NGUYEN

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