VICINITY MAP

OFFICE OF COUNTY ASSESSOR - SANTA CLARA COUNTY, CALIFORNIA

Email: helennguyen3689@gmail.com Tells: (916) 526-5881 & (408) 876-8402

Date: JULY 2024

Scale: AS SHOWN

Reviewed for Code Compliance **☒** Building ☐ Electrical ☐ Plumbing ☐ Mechanical **Cindy Martinez (408) 535-5687** No. 24-091900 <u>Date: 8/29/24</u>

DATE

BY

SHEET NO:

REVISION

TONY NGUYEN 'S RESIDENCE

ITEMS RELATED TO PLUMBING,

3775 NASH CT, SAN JOSE, CA 95121

STRUCTURAL GENERAL NOTES

A. GENERAL

1. ALL WORK SHALL CONFORM TO CURRENT 2022 CBC, CBC, CMC, CPC, 2022 NEC, 2022 CEC. LAWS & ORDINENCES

SMOKE ALARMS – CRC 314 INSTALL SMOKE ALARMS IN EACH SLEEPING ROOM; OUTSIDE EACH SEPARATE SLEEPING AREA IN THE IMMEDIATE VICINITY OF THE BEDROOMS; AND ON EACH ADDITIONAL STORY OF THE DWELLING INCLUDING **BASEMENTS AND HABITABLE ATTICS**

CARBON MONOXIDE ALARMS – CRC 315

INSTALL CO ALARMS OUTSIDE OF EACH SEPARATE

DWELLING UNIT SLEEPING AREA IN THE IMMEDIATE

VICINITY OF THE BEDROOMS; AND ON EVERY LEVEL OF THE DWELLING UNIT, INCLUDING BASEMENTS

- 2. THE CONTRACTOR SHALL VERIFY & BE RESPONSIBLE FOR ALL DIMENTIONS & CONDITIONS AT THE JOB SITE AND SHALL NOTIFY THE ARCHITECT OF ANY DESCREPANCIES BETWEEN ACTUAL CONDITIONS & WHAT IS SHOWN ON THE DRAWINGS BEFORE PROCEDING WITH THE WORK.
- 3. ANY OMISSIONS OR CONFLICTS BETWEEN THE ARCHITECTURAL STRUCTURAL & MECHANICAL DRAWINGS SHALL BE BROUGHT TO THE ATTENTION OF THE CITY INSPECTOR.
- 4. SHOP DRAWINGS REQUIRED BY THE SPECIFICATIONS SHALL BE SUBMITTED TO THE ARCHITECT PRIOR TO FABRICATION, & ALLOW REASONABLE TIME FOR REVIEW AND APPROVAL BY THE STRUCTURAL
- 5. THE CONTRACTOR SHALL BE RESPONSIBLE FOR THE SAFTEY OF THE BUILDING DURING THE CONSTRUCTION. THE CONTRACTOR SHALL PROVIDE ADEQUATE SHORING, BRACING & GUYS IN ACCORDANCE WITH ALL NATIONAL, STATE AND LOCAL SAFETY ORDANCES. ANY DEVIATIONS MUST BE APPROVED PRIOR TO ERECTION.
- 6. ALL CONDITIONS NOT CLEARLY SHOWN OR DETAILED SHALL BE OF THE SAME TYPE & CHARACTER AS THOSE SHOWN FOR SIMILAR CONDITIONS.

B. FOUNDATION

1. FOUNDATION EXCAVATIONS SHALL BE FREE OF LOOSE MATERIAL PRIOR TO THE PLACEMENT OF ANY REINFORCING STEEL OR CONCRETE.

C. CONCRETE

- 1. ALL CONCRETE SHALL HAVE A MINIMUM COMPRESSIVE STRENGTH OF 2500 PSI AT 28 DAYS.
- 2. CONCRETE SHALL BE REGULAR WEIGHT HARD ROCK TYPE(150#CF) & AGREGATE SHALL CONFORM TO ASTM C33 U.O.N.
- 3. CEMENT SHALL CONFORM TO ASTM C150, TYPE 1 OR 2.
- 4. PLACEMENT OF CONCRETE SHALL BE IN CONFORMANCE WITH ACI 301
- 5. CONCRETE SHALL BE MACHINE MIXED AND DELIVERED IN ACCORDANCE WITH ASTM C-94. SUBMIT MIX DESIGN TO THE ARCHITECT FOR APPROVAL PRIOR TO PLACING CONCRETE.
- 6. PROVIDE MINIMUM CLEAR COVER OF CONCRETE OVER REINFORCING AS FOLLOWS

D. REINFORCING STEEL


- 1. ALL REINFORCING STEEL SHALL CONFORM TO ASTM SPECIFICATION A615 GRADE 60 FOR #5 AND LARGER BARS AND GRADE 40 FOR #3 & #4.
- 2. ALL REINFORCING STEEL SHALL BE LAPPED AS NOTED BELOW, #4: 24" FOR BOTTOM BARS AND 28" FOR TOP BARS; #5: 30" FOR BOTTOM BARS AND 35" FOR TOP BARS; #6: 40" FOR BOTTOM BARS AND 46" FOR TOP BARS AT SPLICES UNLESS OTHERWISE NOTED ON PLANS. SPLICES SHALL BE LOCATED AS DETERMINED IN THE PLANS. STAGGER ALL LAPS SPLICES.
- 3. WELDED WIRE FABRIC SHALL CONFORM TO ASTM A82 AND A185.
- 4. ANCHOR BOLTS, DOWELS AND OTHER EMBEDDED ITEMS SHALL BE SECURELY TIED IN PLACE BEFORE CONCRETE IS PLACED, USE CYT THREAD ANCHOR BOLTS ONLY.

E. STRUCTURAL & MISC. STEEL

- 1. FABRICATION AND ERECTION TO BE IN ACCORDANCE WITH LATEST AISC SPECIFICATIONS. STRUCTURAL STEEL SHALL BE ASTM A36, EXCEPT TUBE COLUMNS WHICH ARE ASTM A500, GRADE B.
- 2. WELDING TO BE IN ACCORDANCE WITH AWS SPECIFICATIONS. WELDING SHALL BE PERFORMED BY CERTIFIED WELDERS USING E77XX ELECTRODES.
- 3. ALL PLATES, ETC., TO BE BOLTED TO CONCRETE ELEMENTS, SHALL NOT BE FABRICATED UNTIL THE BOLTS HAVE BEEN LOCATED IN THE
- 4. BOLTS SHALL BE ASTM A307 TYPE. THREADS MAY BE INCLUDED IN THE SHEAR PLANES
- 5. STEEL TO BE SHOP PRIMED FOR, EXCEPT WHERE EMBEDDED IN CONCRETE OR TO BE WELDED.
- 6. ALL WELDING SHALL BE CONTINUOUSLY INSPECTED BY AN INDEPENDENT INSPECTOR APPROVED BY THE BUILDING DEPARTMENT.

F. WOOD FRAME CONSTRUCTION

- 1. GENERAL WOOD FRAMING: WOOD FRAMING THROUGHOUT THE BUILDING SHALL BE CONSTRUCTED IN ACCORDANCE WITH CALIFORNIA BUILDING CODE (2019) AND THE STANDARD PRACTICES RECOMENDED BY AMERICAN INSTITUTE OF TIMBER CONSTRUCTION AND WCLA GRADING. FOR NAILING SEE SECTION J. BOLTS IN WOOD FRAMING SHALL BE STANDARD MACHINE BOLTS WITH STANDARD MALLEABLE IRON WASHERS.
- 3. WOOD PLATES: BEARING DIRECTLY UPON CONCRETE SHALL BE P.T.D.F.
- 4. UNLESS OTHERWISE NOTED ON DRAWINGS OR IN SPECIFICATIONS, FRAMING MEMBERS SHALL HAVE THE FOLLOWING GRADING:

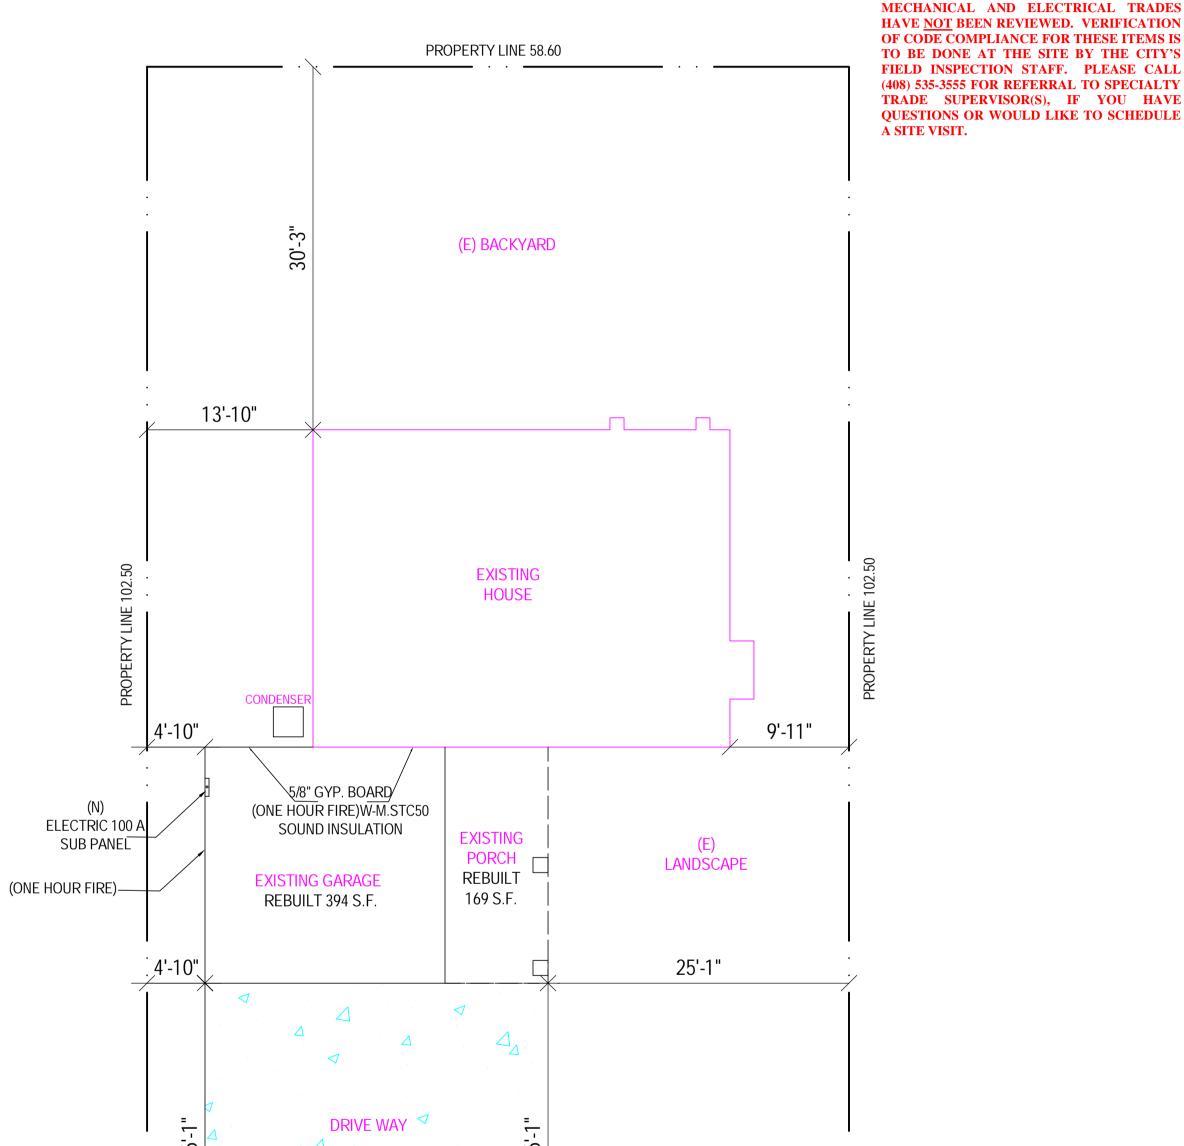

PROPERTY LINE 58.60

SITE PLAN - SCALE: 1 / 8" = 1'-0"

STRUCTURAL GENERAL NOTES SHEET INDEX SITE PLAN, SUMMARY, NOTES, AREA. G. NAIL SCHEDULE EXISTING FLOOR PLAN . WOOD MEMBERS SHALL BE CONNECTED WITH NAILING INDICATED IN PROPOSAL FLOOR AND ELECTRIC PLAN TABLE 2304.9.1 OF 2022 CBC UNLESS GREATER SIZES AND NUMBER OF NAILS ARE SHOWN OR NOTED ON DRAWINGS; NAILS EXPOSED TO **ELEVATIONS PLANS** WEATHER SHALL BE GALVANIZED; NAILS SHALL BE COMMON WIRE EXISTING AND NEW ROOF FRAMING PLANS NAILS; HOLES FOR NAILS SHALL BE PROVIDED WHERE THE WOOD TENDS TO SPLIT: SPLIT WOOD MEMBERS SHOULD BE REPLACED AND GENERAL STRUCTURAL NOTES REMOVED FROM THE JOB PROMPTLY. SHORT PLYWOOD NAILS FOR EQUIVALENT SHEAR VALUE MAY BE USED. SEE PLANS FOR NAIL FOUNDATION PLAN SPACING. NAIL ROOF SHEATHING 8d @ 6" O.C. AT SUPPORTED EDGES. 8d @ 10 INCHES O.C. AT INTERMEDIATE SUPPOERTS. FLOOR FOUNDATION DETAILS SHEATHING 8d @ 6" O.C. AT BOUNDARIES AND PANEL EDGES AND 8d @ 10" O.C. AT INTERMEDIATE SUPPORTS. PLYWOOD CEILING FRAMING PLAN WALL SHEATHING SHALL BE NAILED PER SHEAR WALL SCHEDULE AT SHEAR WALLLS, AND AT A MINIMUM OF 8d @ 6" O.C. ALL OTHER ROOF FRAMING PLAN **ROOF DETAILS** 2. AT PRESSURE TREATED LUMBER USE HOT-DIPPED GALVANIZED, STAINLESS STEEL, SILICON BRONZE, OR COPPER. STRUCTURAL CALCULATION T-24 ENERGY REPORT CG-1 CAL GREEN MANDATORY CG-2 CAL GREEN MANDATORY LOW - RISE - MANDATORY- MEASURES- SUMMARY FASTENING SCHEDULE PER CRC TABLE R602.3 (1) APPLICABLE CODES NOTES

CODE COMPLIANCE

ALL CONSTRUCTION SHALL CONFORM TO ALL GOVERNING LAWS, CODES AND ORDINANCES INCLUDING BUT NOT LIMITED TO THE FOLLOWING: -2022 CALIFORNIA BUILDING CODES: CBC, CMC, CPC, CFC & CEC, CRC. -2022 CA ENERGY CODE

PROJECT DATA

494-68-024

R-E1-W4

6,112 S.F

R-3/U

NONE

1980

2,750 S.F.

(FLAT)

394 S.F.

169 S.F.

SCOPE OF WORK

REBUILD FRAMING WALL AND ROOF THE EXISTING GARAGE 394 S.F.

AND PORCH 169 S.F. IN FRONT OF THE HOUSE.

(E) FOOTING GARAGE TO REMAIN

V-B

SINGLE FAMILY RESIDENCE

EXISTING PROPOSAL

TOTAL

1,890 S.F

394 S.F.

1,890 S.F.

30,9 %

3375 NASH CT, SAN JOSE, CA 95121

EXISTING USE

LOCATION:

ZONING:

LOT GROSS SIZE:

FIRE SPRINKLER:

YEAR BUILT:

FLOOR AREA:

DWELLING:

GARAGE:

PORCH:

TOTAL FOOTPRINT:

OCCUPANCY GROUP:

TYPE OF CONSTRUCTION:

ALLOWABLE FLOOR AREA:

LOT AVERAGE SLOPE:

-CITY OF SAN JOSE MUNICIPAL CODE -ALL LOCAL ORDINANCES


a) Please note that a Building Permit cannot be issued until all clearances by all reviewing departments (listed above) have been approved on the project. Check the status of your permit by visiting www.sjpermits.org and contact the individual departments directly with any

b) Revised plans, when required, must be clouded with delta number with a revision mark at each location where revision has occurred and be noted that additional comments may be triggered once revised plan are

c)When comments cite a section of code and require a revision, correction or amendment to plans, required information shall be specifically & directly provided on plans. Generic references to code section(s) is not acceptable.

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Main Breaker Size in amps, example: 100 amps, 150 amps, etc.

3. Enter electrical load calculation (amp rating) for the new ADU:

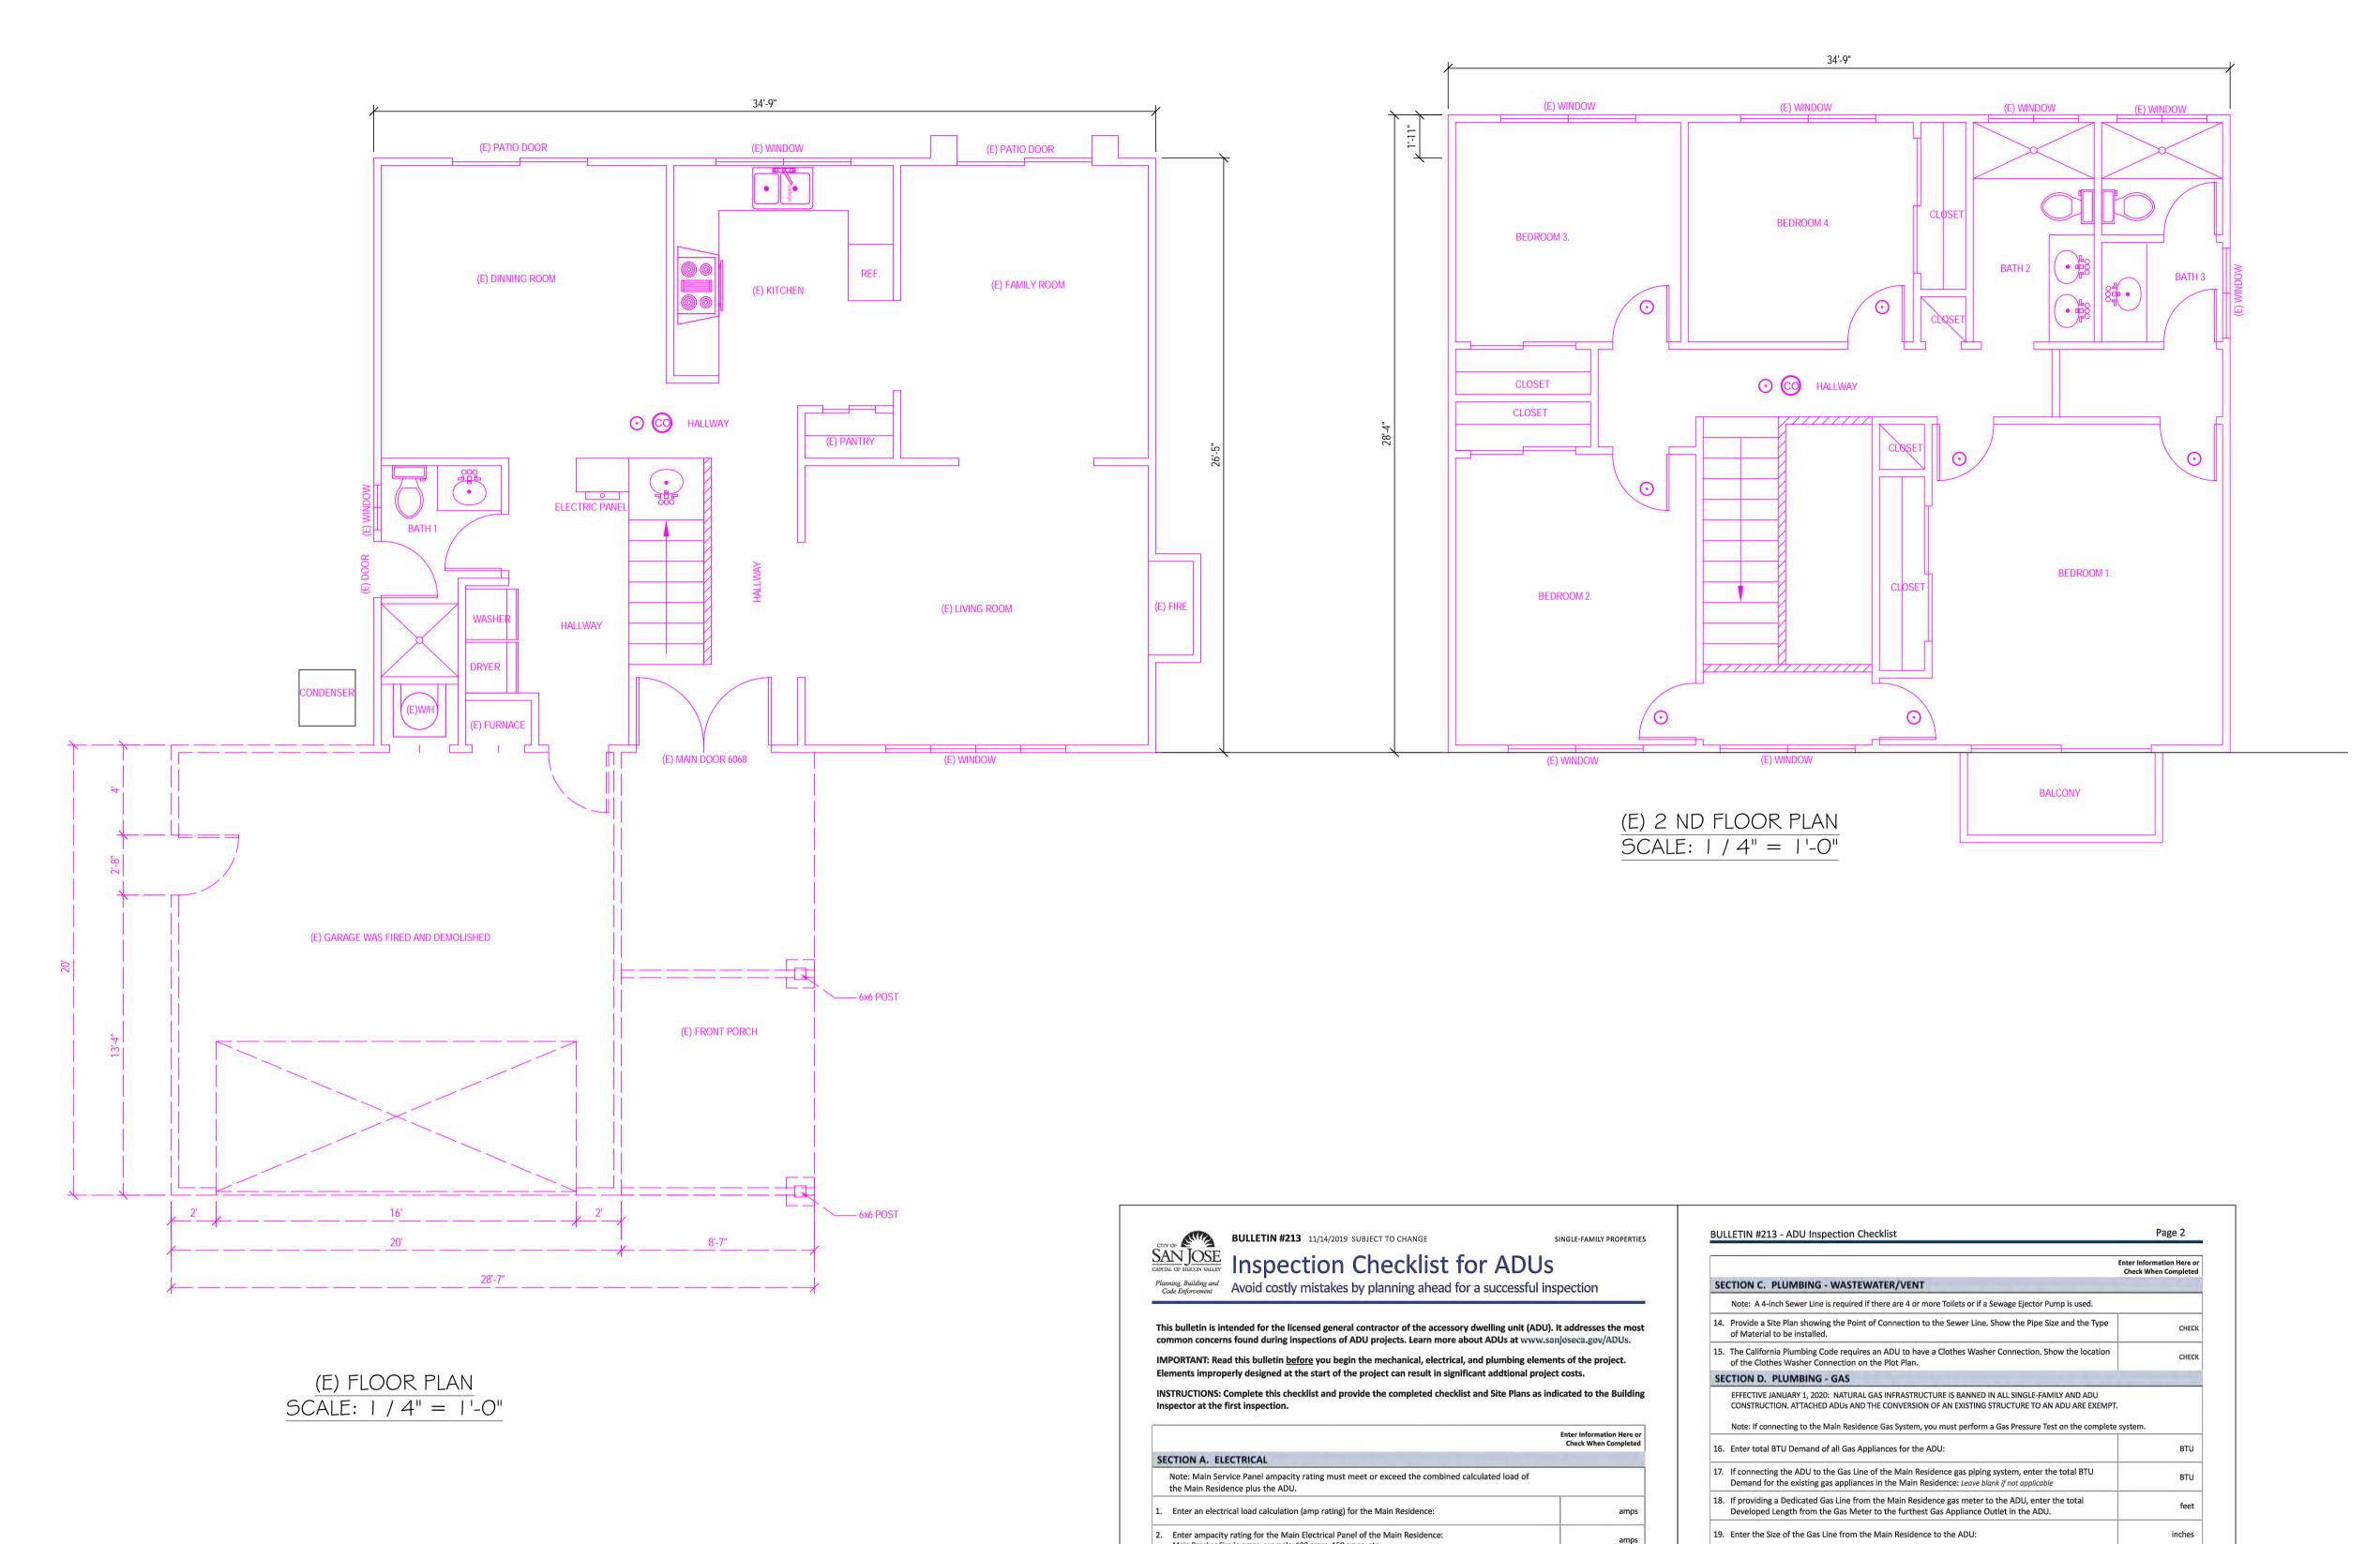(Disconnect Breaker) to the ADU:

8. Water Pressure in the main line:

7. Quantity of Plumbing Fixtures for the new ADU:

4. Enter amperage rating of the Feeder Disconnect serving the ADU (panel electrical breaker size):

5. Enter size of the Electrical Feeder Circuit Wiring from the electrical panel at the Main Residence

6. Quantity of Plumbing Fixtures (sinks, toilets, showers, hose bibs, etc.) in the Main Residence:

12. Size of Water Branch Line between ADU and the Main Residence, only if supplying the ADU from the

13. Provide a Site Plan showing the Water Service Lines. If connecting to the Main residence water piping, show the Point of Connection. For both water service lines, show Pipe Size and Type of Material to be

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9. Distance from the Water Meter to the furthest plumbing fixture in the ADU:

10. Size of Water Service Line from the water meter to the Main Residence.

11. Size of Water Service Line from the water meter to the ADU.

Main Residence water piping. Leave blank if not applicable.

19. Enter the Size of the Gas Line from the Main Residence to the ADU: inches 20. Provide a Site Plan that shows the Point of the Gas Connection from the Main Residence to the Point of 21. Provide a Detail of Underground Gas Piping Material and Burial Depth. Underground gas piping must be approved for direct burial. Note: Installation of Gas Service Laterals under or through Structures, Building, 22. Bathroom Exhaust Fans shall be listed/rated for a minimum of 25cfm for continuous use and 50cfm for intermittent use. 23. Bathroom Exhaust Fans must be equipped with a Humidity Control. CHECK 24. Kitchen Exhaust Fans must be listed for the intended use and must be a minimum of 100 cfm. 25. Kitchen Exhaust must be ducted to the Exterior of the Dwelling and be equipped with a Backdraft CHECK 26. The ADU must have an independent Heating Source. The return air is prohibited from communicating with the Main Residence. 27. Ventilation air is required per California Mechanical Code (CMC) section 402.1. For new structures, CHECK provide outside air at a minimum rate of 0.06 cfm per square foot of Habitable Area. 28. Infiltration shall not be considered in an attached ADU to meet outdoor air requirements.

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ELECTRICAL LEGENDS


- CEILING RECEPTACLE OUTLET
- DUPLEX RECEPTACLE, MTD @ 12" U.O.N.
- → SINGLE OUTLET
- **⊕** 220V OUTLET
- WP WEATHERPROOF DUPLEX OUTLET W/GFGI
- GFI DUPLEX OUTLET W/GROUND FAULT INTERRUPTER
- DUPLEX RECEPTACLE, MTD@+12" U.O.N. SPLIT WIRE WITH HALF SW/CONTROLLED
- SPECIAL PURPOSE
- FLOOR DUPLEX RECEPTACLE OUTLET
- CARBON MONOXIDE SMOKE DETECTOR W/BATTERY BACK UP
- -♦- CEILING LIGHT
- FLUORESCENT LIGHT
- RECESSED CANISTER
- FLOOR OUTLET (DBL)
- **SWITCH**
- \$3 3 WAY SWITCH \$4 4 WAY SWITCH
- DIMMER SWITCH
- \$T TIMER SWITCH
- CEILING FAN
- → FUEL GAS
- FAN TO OUTSIDE AIR
- CARBON MONOXIDE SMOKE
 DETECTOR W/BATTERY BACK UP
- INCANDESCENT LIGHT FIXTURE (CEILING)
- -O- WEATHERPROOF LIGHT FIXTURE
- DISPOSAL
- O RECESSED LIGHT FIXTURE
- FAN TO OUTSIDE AIR

OOO CHIME

- PUSH BUTTON
- ⊢⊢G GAS RISER
- HB HORSE BID WITH BACKFLOW PREVENTATION → DEVICE
- HB HOSE BIBB SOV SHUT OFF VALVE
- ∘□\ BELL/BUZZER
- ELECTRICAL DISCONNECT
- DECORATIVE ABOVE MIRROR
- **BATHROOM LIGHT** SD CIRCUIT BREAKER
- ∐ KEY
- MOTION SENSOR
- CHANDELIER
- FLOOR SUPPLY AIR REGISTER
- CEILING SUPPLY AIR REGISTER FLOURESCENTLIGHT FIXUTE (SURFACE) SEE PLAN



LEGEND

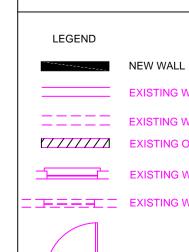

EXISTING WALL TO REMAIN.

EXISTING DOORS TO REMAIN

EXISTING WALL TO BE REMOVE EXISTING OPENING TO BE ENCLOSED EXISTING WINDOW TO REMAIN

EXISTING WINDOW TO BE REMOVED

SHEET NO:

DATE

REVISION

TOMMY DRAFTING

9743 WHITE PINE WAY, ELK GROVE, CA 95624 Email: helennguyen3689@gmail.com Tells: (916) 526-5881 & (408) 876-8402

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Signed:

Drawn: LUYEN HONG NGUYEN

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3. ALL LUMBER USED IN CONSTRUCTION LOCATED NEARER THAN 8" TO EARTH SHALL BE F.G. RWD OR P.T.

4. PROVIDE SOLID BLOCKING FOR ALL PONY WALLS LESS THAN 14" HIGH

5. PROVIDE FIRESTOPS @ CONCEALED DRAFT OPENING, CEILING LINES, FLOOR LINES, FURRED AREAS, SUSPENDED CEILINGS, STAIR STRINGERS, SHOWERS, CHIMNEY ENCLOSURES, & MID HEIGHT OF WALLS OVER 10' IN HEIGHT.

6. VERIFY MIN. 22"x30" FLOOR ACCESS. ATTIC ACCESS WITH 30" CLEARING ABOVE OPENING.

7. DOORS, WINDOWS, & SHOWER DOORS WITHIN HAZARDOUS AREAS TO BE TEMPERED.

8. ALL POSTS, BEAMS & WALLS SUPPORTING THE FLOOR/ CEILING SHALL HAVE ONE-HOUR FIRE PROTECTION.

9. ALL NEW WINDOWS AND GLASS SLIDING DOOR SHALL BE LOW-E DUAL GLAZED U.N.O.

10. MATERIAL GRADE STAMPS WILL BE CHECKED ON FRAME INSPECTION.

11. ALL CONSTRUCTION SHALL COMPLY WITH THE 2022 EDITION OF THE CBC, CMC, CPC, CEC, CRC AND CFC AND THE 2022 CALIFORNIA ENERGY CODE.

12. CHANGES FROM THE APPROVED PLANS DURING CONSTRUCTION OTHER THAN 1.) CABINET CHANGES WHEN NOT BEING SUPPORTED ENTIRELY BY THE ROOF STRUCTURE, APPROVED PLAN, 2.) INTERIOR NON-STRUCTURAL WALL FINISHES; SHALL CAUSE PLAN APPROVAL AND CONSTRUCTION TO BE SUSPENDED. A NEW PLAN CHECK (FOR A NEW PLAN) SHOWING CHANGES WILL BE SUBMITTED FOR REVIEW AND APPROVAL THROUGH THE NORMAL PLAN CHECK PROCESS.

13. FIREBLOCKING WITH NON-COMBUSTIBLE MATERIAL SHALL BE PROVIDED IN OPENINGS AROUND VENTS, PIPES, DUCTS, FIREPLACES, AND SIMILAR OPENINGS PER CBC 708.2.1 (4).

14. PROVIDE SMOKE DETECTORS (HARDWIRED 110v W/BATT BACK-UP) IN EVERY BEDROOMS, THE HALL WAY TO THE BEDROOM, PROVIDE CARBON MONOXIDE SMOKE ALARM DETECTOR IN ALL SLEEPING ROOM.

15. IN EACH NEW BEDROOM, THERE IS AT LEAST ONE WINDOW, FOR EMERGENCY ESCAPE OR RESCUE: REQUIRE OPENING OF MINIMUM NET CLEAR AREA, 5.7 SQ. FT. HEIGHT 24", WIDTH 20", AND MAXIMUM FINISHED OPENING HEIGHT 44"ABOVE FINNISH FLOOR

16. NEW 3'X3' MIN, CONCRETE LANDING AT ALL NEW EXTERIOR DOOR. LANDING SHALL NOT BE LOWER THAN 7-1/2" FROM FLOOR LEVEL.

17. BATHROOM SLIDING DOOR MUST BE TEMPERED GLASS.

18. ALL NEW BEDROOM MUST BE AFCI CIRCUIT.

19. PRESSURE OR THERMOSTATIC MIXING VALVE AT THE SHOWERS AND TUBS, WHICH LIMIT WATER TEMPERATURE TO 120 DEGREES F

20. THE SHOWERS MUST HAVE INSIDE DEMENSION OF AT LEAST 30 INCHES, THE TOTAL FLOOR AREA OF A SHOWER MUST BE AT LIST 1,024 SQUARE INCHES, OPENING TO SHOWER MUST BE MIN. 24 INCHES WIDE, THE DOOR MUST BE TEMPERED GLASS.(SEE DETAILS)

ELECTRICAL NOTES:

MOTION SENSOR WITH INTEGRAL PHOTOCONTROL

2. ALL HARDWIRED LIGHTING IN BATHROOMS, GARAGES, LAUNDRY AND UTILITY ROOMS MUST BE HIGH EFFICACY OR CONTROLLED BY A MANUAL-ON MOTION SENSOR

3. ALL HARDWIRED LIGHTING IN OTHER ROOMS (HALLWAYS, DINING ROOMS, FAMILY ROOMS AND BEDROOMS) SHALL BE HIGH EFFICACY OR CONTROLLED BY A MANUAL-ON OCCUPANT SENSOR OR A DIMMER MUST CONTROL IT

4. ALL SWITCHES ON A MULTIPLE SWITCHED CIRCUIT SHALL BE CONTROLLED BY THE DIMMER SWITCH ON THAT CIRCUIT

5. ALL RECESSED FIXTURES SHALL BE LABELED AS BEING CERTIFIED TO HAVE A LEAKAGE RATING OF LESS THAN 2.0 AT 75 PASCAL

6. ALL HIGH EFFICACY FIXTURES AND NON-HIGH EFFICACY FIXTURES SHALL BE SWITCHED SEPARATELY

7. SMOKE DETECTOR SYSTEM SHALL BE HARD-WIRED, INTERCONNECTED TO SOUND SIMULTANIOUSLY AND EQUIPED WITH BATTERY BACK UP.

8. MIN. 50%OF WATTAGE OF LIGHTS IN KITCHEN SHALL BE HIGH EFFICACY AND THOSE THAT ARE NOT SHALL BE SWITCHED SEPARATELY


9. LIGHTS MOUNTED TO EXTERIOR OF BUILDING SHALL BE HIGH EFFICACY OR ON A PHOTO CONTROL/MOTION SENSOR COMBINATION

LAMP POWER RATING:	MINIMUM LAMP EFFICACY:
15 watts or less	40 lumens per watt
over 15 watts to 40 watts	50 lumens per watt
over 40 watts	60 lumens per watt

NOTES:

WATER-RESISTANT GYPSUM BACKING BOARD SHALL NOT BE USED WHERE THERE WILL BE DIRECT EXPOSURE TO WATER. OR IN AREAS SUBJECT TO CONTINUOUS HIGH HUMINITY . R702.3.7.1

on plan the fire-resistance-rated floor/ceiling and wall assemblies shall extend to and be tight against the exterior wall, and wall assemblies shall extend from the foundation to the underside of the roof sheathing or rated floor/ceiling

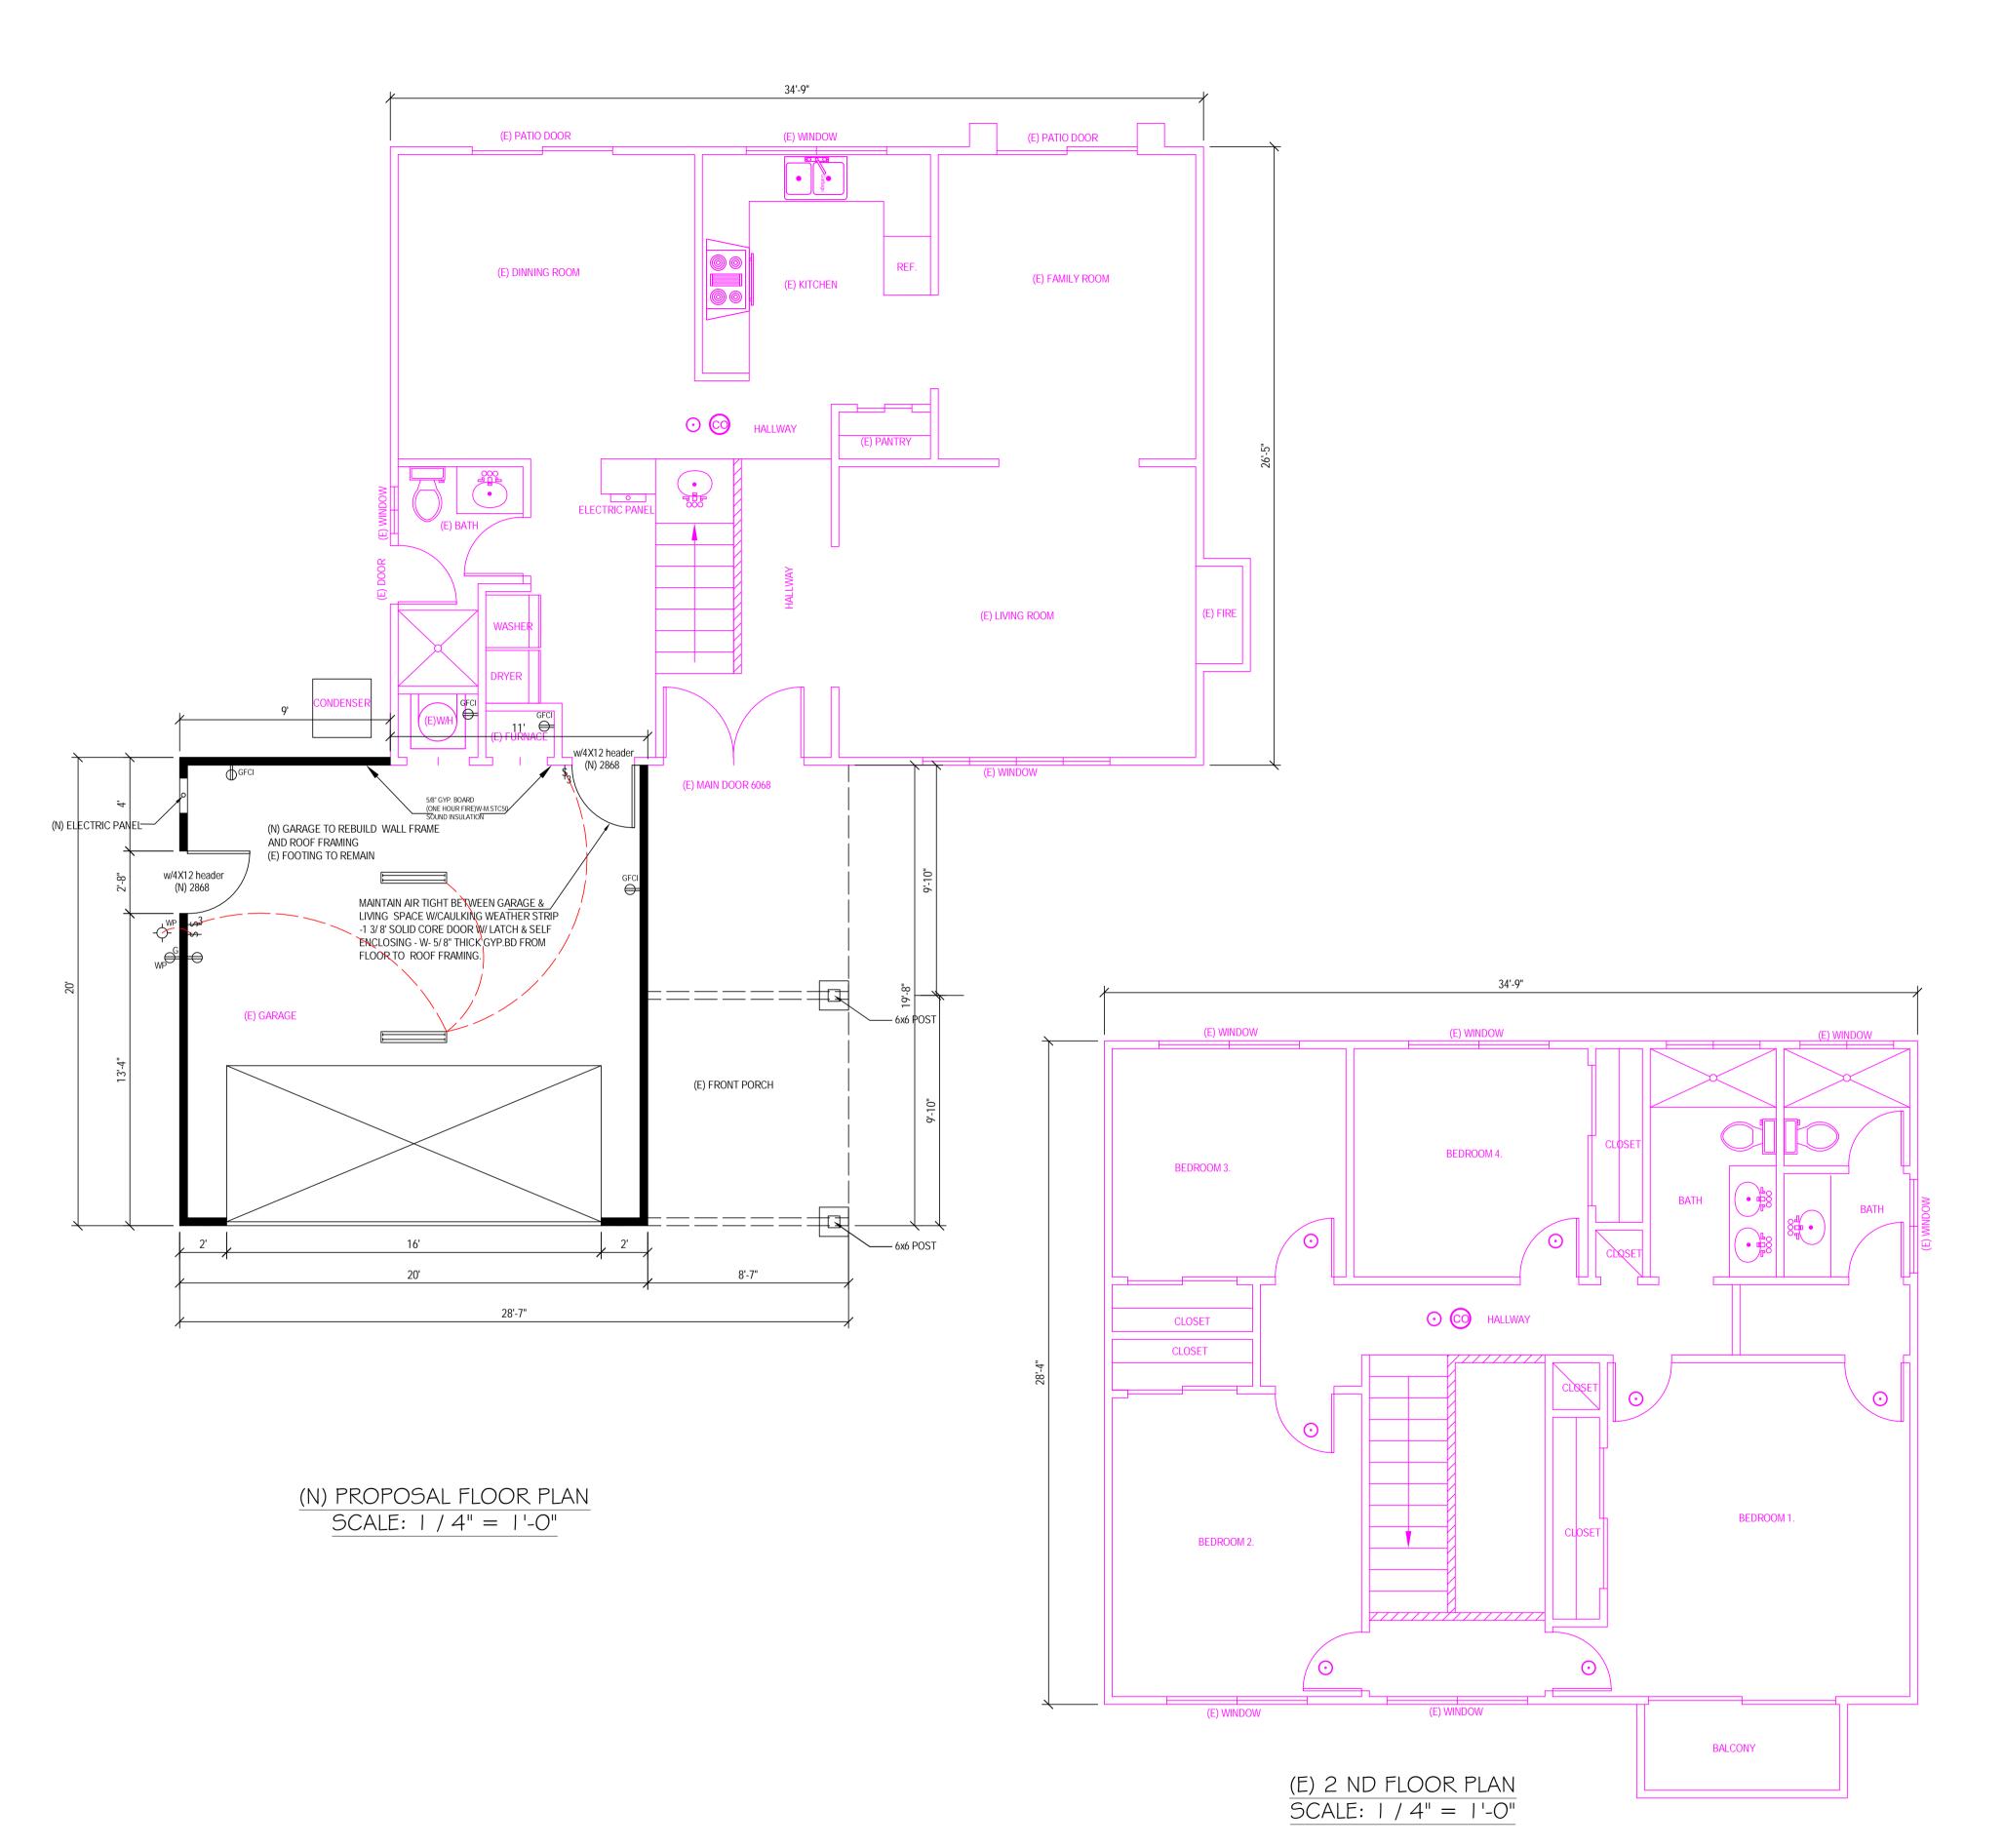

ELECTRICAL LEGENDS

© CEILING RECEPTACLE OUTLET

DUPLEX RECEPTACLE, MTD @ 12" U.O.N.

⇒ SINGLE OUTLET

⇒ 220V OUTLET

WEATHERPROOF DUPLEX OUTLET W/GFGI

GFI DUPLEX OUTLET W/GROUND FAULT INTERRUPTER

DUPLEX RECEPTACLE, MTD@+12" U.O.N. SPLIT WIRE WITH HALF SW/CONTROLLED

SPECIAL PURPOSE

FLOOR DUPLEX RECEPTACLE OUTLET CARBON MONOXIDE SMOKE DETECTOR W/BATTERY BACK UP

-♦ CEILING LIGHT

FLUORESCENT LIGHT

RECESSED CANISTER

SWITCH

\$3 3 WAY SWITCH

\$4 4 WAY SWITCH

DIMMER SWITCH \$T TIMER SWITCH

CEILING FAN

→ FUEL GAS

FAN TO OUTSIDE AIR

©D CARBON MONOXIDE SMOKE DETECTOR W/BATTERY BACK UP

- INCANDESCENT LIGHT FIXTURE (CEILING) → WEATHERPROOF

LIGHT FIXTURE

O RECESSED LIGHT FIXTURE

FAN TO OUTSIDE AIR

PUSH BUTTON

HB | HOSE BIBB SOV SHUT OFF VALVE

∘□\ BELL / BUZZER


ELECTRICAL DISCONNECT

BATHROOM LIGHT

CHANDELIER

FLOURESCENTLIGHT FIXUTE (SURFACE) SEE PLAN



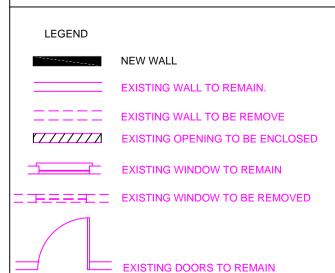



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Drawn: LUYEN HONG NGUYEN

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REVISION

OOO CHIME

DISPOSAL

⊢G GAS RISER

GAS STUB

HB HORSE BID WITH BACKFLOW PREVENTATION → DEVICE


DECORATIVE ABOVE MIRROR

SD CIRCUIT BREAKER ∐ KEY

MOTION SENSOR

FLOOR SUPPLY AIR REGISTER



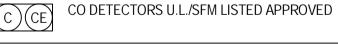



SHEET NO:

DATE

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