### STRUCTURAL GENERAL NOTES

### A. GENERAL

- 1. ALL WORK SHALL CONFORM TO CURRENT 2019 UBC, CBC, CMC, CPC, 2019 NEC, 2019 CEC.LAWS & ORDINENCES
- 2. THE CONTRACTOR SHALL VERIFY & BE RESPONSIBLE FOR ALL DIMENTIONS & CONDITIONS AT THE JOB SITE AND SHALL NOTIFY THE ARCHITECT OF ANY DESCREPANCIES BETWEEN ACTUAL CONDITIONS & WHAT IS SHOWN ON THE DRAWINGS BEFORE PROCEDING WITH THE WORK.
- 3. ANY OMISSIONS OR CONFLICTS BETWEEN THE ARCHITECTURAL STRUCTURAL & MECHANICAL DRAWINGS SHALL BE BROUGHT TO THE ATTENTION OF THE CITY INSPECTOR.
- 4. SHOP DRAWINGS REQUIRED BY THE SPECIFICATIONS SHALL BE SUBMITTED TO THE ARCHITECT PRIOR TO FABRICATION, & ALLOW REASONABLE TIME FOR REVIEW AND APPROVAL BY THE STRUCTURAL ENGINEER
- 5. THE CONTRACTOR SHALL BE RESPONSIBLE FOR THE SAFTEY OF THE BUILDING DURING THE CONSTRUCTION. THE CONTRACTOR SHALL PROVIDE ADEQUATE SHORING, BRACING & GUYS IN ACCORDANCE WITH ALL NATIONAL, STATE AND LOCAL SAFETY ORDANCES. ANY DEVIATIONS MUST BE APPROVED PRIOR TO ERECTION.
- 6. ALL CONDITIONS NOT CLEARLY SHOWN OR DETAILED SHALL BE OF THE SAME TYPE & CHARACTER AS THOSE SHOWN FOR SIMILAR CONDITIONS

#### B. FOUNDATION

1. FOUNDATION EXCAVATIONS SHALL BE FREE OF LOOSE MATERIAL PRIOR TO THE PLACEMENT OF ANY REINFORCING STEEL OR CONCRETE.

#### C. CONCRETE

- 1. ALL CONCRETE SHALL HAVE A MINIMUM COMPRESSIVE STRENGTH OF 2500 PSI AT 28 DAYS.
- 2. CONCRETE SHALL BE REGULAR WEIGHT HARD ROCK TYPE(150#CF) & AGREGATE SHALL CONFORM TO ASTM C33 U.O.N.
- 3. CEMENT SHALL CONFORM TO ASTM C150, TYPE 1 OR 2.
- 4. PLACEMENT OF CONCRETE SHALL BE IN CONFORMANCE WITH ACI 301.
- 5. CONCRETE SHALL BE MACHINE MIXED AND DELIVERED IN ACCORDANCE WITH ASTM C-94. SUBMIT MIX DESIGN TO THE ARCHITECT FOR APPROVAL PRIOR TO PLACING CONCRETE.
- 6. PROVIDE MINIMUM CLEAR COVER OF CONCRETE OVER REINFORCING AS FOLLOWS

#### D. REINFORCING STEEL

- 1. ALL REINFORCING STEEL SHALL CONFORM TO ASTM SPECIFICATION A615 GRADE 60 FOR #5 AND LARGER BARS AND GRADE 40 FOR #3 & #4.
- 2. ALL REINFORCING STEEL SHALL BE LAPPED AS NOTED BELOW, #4: 24" FOR BOTTOM BARS AND 28" FOR TOP BARS; #5: 30" FOR BOTTOM BARS AND 35" FOR TOP BARS; #6: 40" FOR BOTTOM BARS AND 46" FOR TOP BARS AT SPLICES UNLESS OTHERWISE NOTED ON PLANS. SPLICES SHALL BE LOCATED AS DETERMINED IN THE PLANS. STAGGER ALL LAPS SPLICES.
- 3. WELDED WIRE FABRIC SHALL CONFORM TO ASTM A82 AND A185.
- 4. ANCHOR BOLTS, DOWELS AND OTHER EMBEDDED ITEMS SHALL BE SECURELY TIED IN PLACE BEFORE CONCRETE IS PLACED, USE CYT THREAD ANCHOR BOLTS ONLY.

# E. STRUCTURAL & MISC. STEEL

- 1. FABRICATION AND ERECTION TO BE IN ACCORDANCE WITH LATEST AISC SPECIFICATIONS. STRUCTURAL STEEL SHALL BE ASTM A36, EXCEPT TUBE COLUMNS WHICH ARE ASTM A500, GRADE B.
- 2. WELDING TO BE IN ACCORDANCE WITH AWS SPECIFICATIONS. WELDING SHALL BE PERFORMED BY CERTIFIED WELDERS USING E77XX ELECTRODES.
- 3. ALL PLATES, ETC., TO BE BOLTED TO CONCRETE ELEMENTS, SHALL NOT BE FABRICATED UNTIL THE BOLTS HAVE BEEN LOCATED IN THE FIELD.
- 4. BOLTS SHALL BE ASTM A307 TYPE. THREADS MAY BE INCLUDED IN THE SHEAR PLANES
- 5. STEEL TO BE SHOP PRIMED FOR, EXCEPT WHERE EMBEDDED IN CONCRETE OR TO BE WELDED.
- 6. ALL WELDING SHALL BE CONTINUOUSLY INSPECTED BY AN INDEPENDENT INSPECTOR APPROVED BY THE BUILDING DEPARTMENT.

# F. WOOD FRAME CONSTRUCTION

- 1. GENERAL WOOD FRAMING: WOOD FRAMING THROUGHOUT THE BUILDING SHALL BE CONSTRUCTED IN ACCORDANCE WITH CALIFORNIA BUILDING CODE (2019) AND THE STANDARD PRACTICES RECOMENDED BY AMERICAN INSTITUTE OF TIMBER CONSTRUCTION AND WCLA GRADING. FOR NAILING SEE SECTION J. BOLTS IN WOOD FRAMING SHALL BE STANDARD MACHINE BOLTS WITH STANDARD MALLEABLE IRON WASHERS.
- 3. WOOD PLATES: BEARING DIRECTLY UPON CONCRETE SHALL BE P.T.D.F.
- 4. UNLESS OTHERWISE NOTED ON DRAWINGS OR IN SPECIFICATIONS, FRAMING MEMBERS SHALL HAVE THE FOLLOWING GRADING:

# SHEET INDEX:

- SITE PLAN / ROOF PLAN, SUMMARY, NOTES, AREA.
   PROPOSAL FLOOR AND ELECTRIC PLAN
- 3. ELEVATION PLAN
- 4. FOUNDATION PLANS AND DETAILS
- 5. ROOF FRAMING AND DETAILS
- 6. T-24 ENERGY REPORT 7. CAL GREEN
- 8. 2019 LR

### G. NAIL SCHEDULE

- 1. WOOD MEMBERS SHALL BE CONNECTED WITH NAILING INDICATED IN TABLE 2304.9.1 OF 2019 CBC UNLESS GREATER SIZES AND NUMBER OF NAILS ARE SHOWN OR NOTED ON DRAWINGS; NAILS EXPOSED TO WEATHER SHALL BE GALVANIZED; NAILS SHALL BE COMMON WIRE NAILS; HOLES FOR NAILS SHALL BE PROVIDED WHERE THE WOOD TENDS TO SPLIT; SPLIT WOOD MEMBERS SHOULD BE REPLACED AND REMOVED FROM THE JOB PROMPTLY. SHORT PLYWOOD NAILS FOR EQUIVALENT SHEAR VALUE MAY BE USED. SEE PLANS FOR NAIL SPACING. NAIL ROOF SHEATHING 8d @ 6" O.C. AT SUPPORTED EDGES. 8d @ 10 INCHES O.C. AT INTERMEDIATE SUPPOERTS. FLOOR SHEATHING 8d @ 6" O.C. AT BOUNDARIES AND PANEL EDGES AND 8d @ 10" O.C. AT INTERMEDIATE SUPPORTS. PLYWOOD WALL SHEATHING SHALL BE NAILED PER SHEAR WALL SCHEDULE AT SHEAR WALLLS, AND AT A MINIMUM OF 8d @ 6" O.C. ALL OTHER
- 2. AT PRESSURE TREATED LUMBER USE HOT-DIPPED GALVANIZED, STAINLESS STEEL, SILICON BRONZE, OR COPPER.

### G. FIRE SPRINKES

ALL CONSTRUCTION SITES MUST COMPLY WITH APPLICABLE PROVISION
OFF THE CFC CHAPTER 14 AND OUR STANDARD DETAIL AND SPECIFICATION SI-7

# LOT INFORMATION

HAO TAN DOAN RESIDENCE OWNER: 4109 RUTLEDGE WAY, CARMICHAEL, CA 95608 LOCATION: SINGLE FAMILY RESIDENCE **EXISTING USE:** A.P.N.: 2450231004 LOT GROSS SIZE: 10,019 S.F. CONSTRUCTION TYPE: VΒ ALLOWABLE FLOOR AREA: 4,509 S.F LOT AVERAGE SLOPE: (FLAT) TOTAL FLOOR AREA: EXISTING PROPOSAL 1,200 S.F. 1,200 S.F. DWELLING: 384 S.F. 384 S.F. GARAGE: 384 S.F. TOTAL FOOTPRINT: 1,584 S.F.

### SCOPE OF WORK

F.A.R.:

(E) GARAGE CONVERT TO BE JADU 384 S.F INCLUDED: 1 BEDROOM, 1 BATHROOM AND 1 KITCHEN

15.8 %

## CODE COMPLIANCE

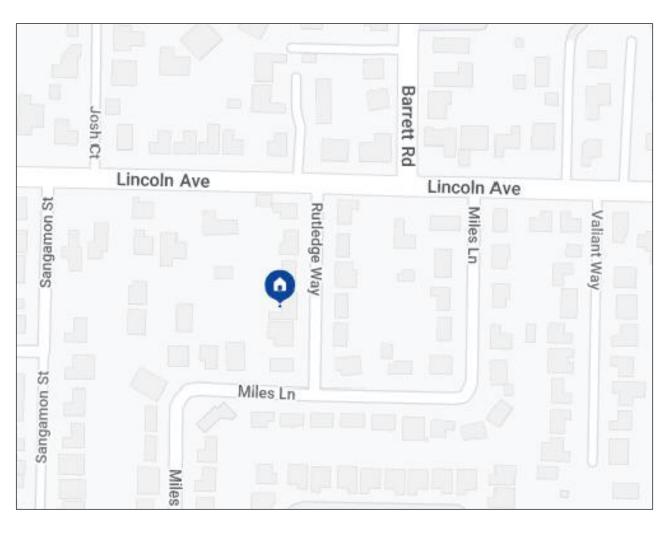
ALL CONSTRUCTION SHALL CONFORM TO ALL GOVERNING LAWS, CODES AND ORDINANCES INCLUDING BUT NOT LIMITED TO THE FOLLOWING:

-2019 CALIFORNIA BUILDING CODES: CBC, CMC, CPC, CFC & CEC, CRC.


-2019 CA ENERGY CODE

-CITY OF CARMICHAEL MUNICIPAL CODE

-ALL LOCAL ORDINANCES



VICINITY MAP

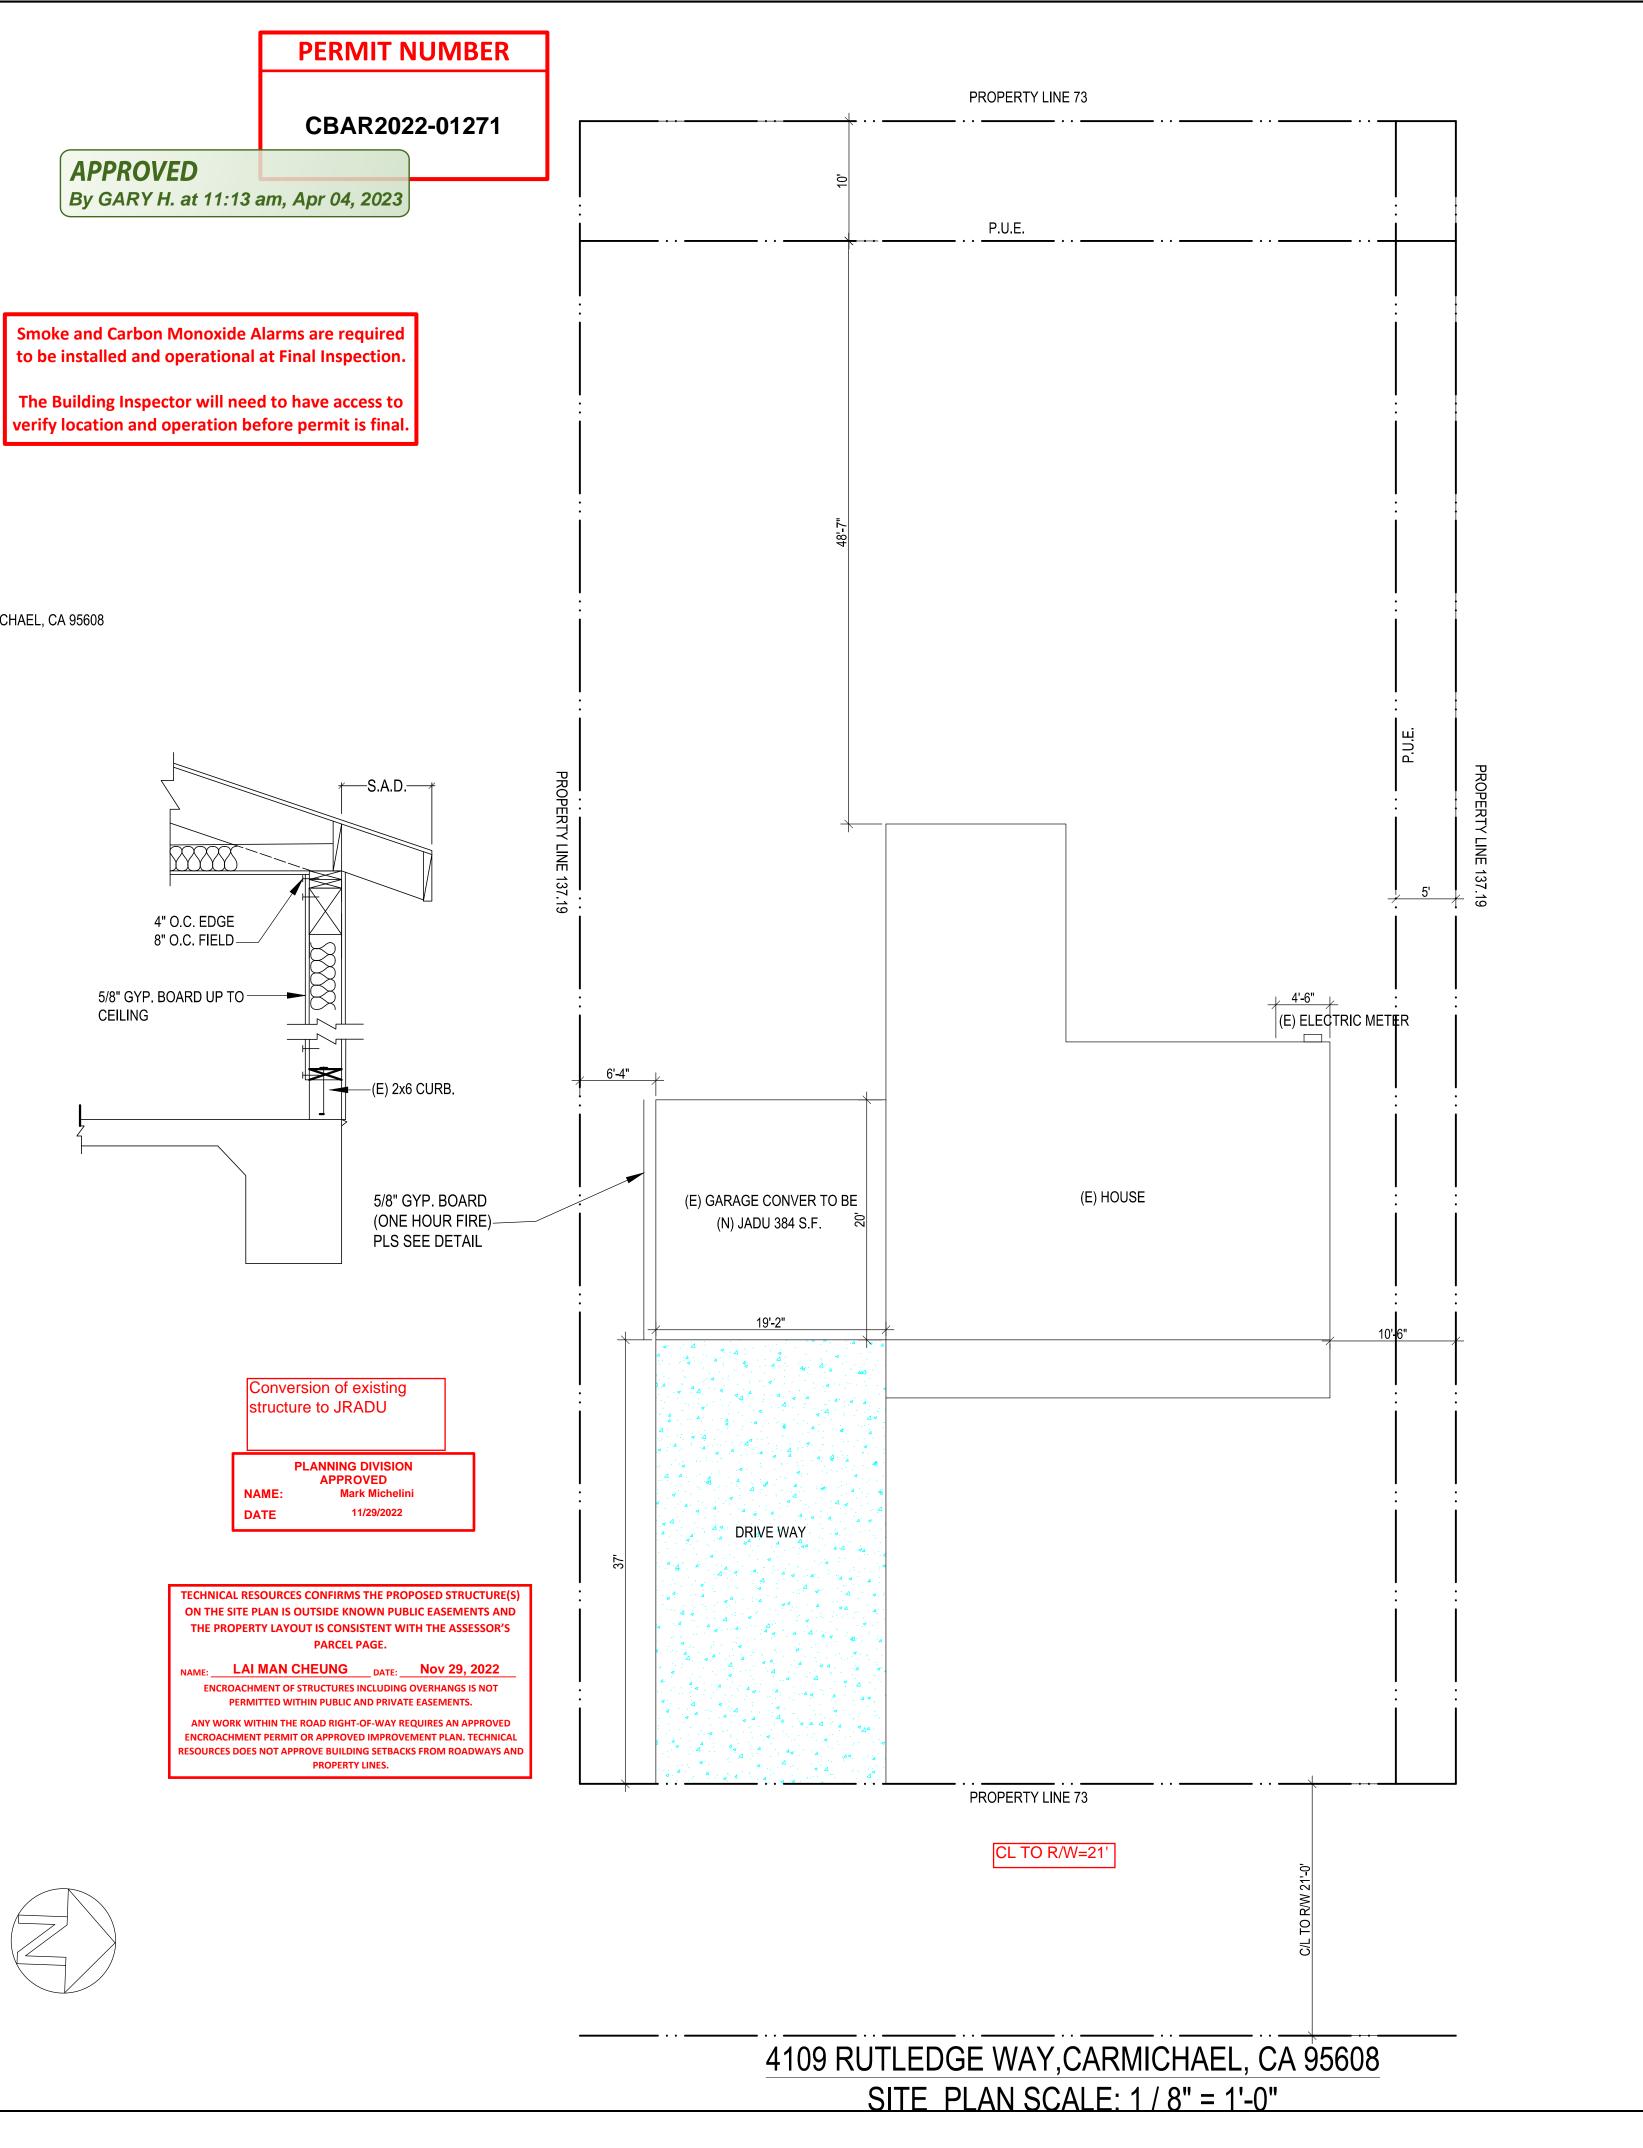

BAJ GRAPHIC DESIGN

Date: NOVEMBER 2022
Scale: AS SHOWN

Email: william\_t55@yahoo.com & helennguyen3689@gmail.c Phone: (408) 876-8402 & (916) 526-5881 Address: 9743 WHITE PINE WAY, ELK GROVE, CA 95624 1449 BOB WHITE PLACE, SAN JOSE, CA 95131

Prawn: WILLIAM TRAN & LUYEN HONG NGUYEN

Signed: Thruy

Owner: 4109 RUTLEDGE WAY, CARMICHAEL, CA 95600 (530) 723-4708 HAODOANPOWER@YAHOO.COM

HAO TAN DOAN RESIDENCE ) GARAGE CONVERT TO BE JADU JTLEDGE WAY,CARMICHAEL, CA 95608

REVISION

BY

JOB **04/04/2023** 

SHEET NO:

**A-**1

# FLOOR PLAN NOTES:

ONE-HOUR FIRE PROTECTION.

- 1. ALL CONCRETE TO BE POURED ON UNDISTURBED SOIL.
- 2. ALL LUMBER IN CONTACT WITH CONCRETE SHALL BE FOUNDATION GRADE RWD OR PRESSURE TREATED.
- 3. ALL LUMBER USED IN CONSTRUCTION LOCATED NEARER THAN 8" TO EARTH SHALL BE F.G. RWD OR P.T.
- 4. PROVIDE SOLID BLOCKING FOR ALL PONY WALLS LESS THAN 14" HIGH
- 5. PROVIDE FIRESTOPS @ CONCEALED DRAFT OPENING, CEILING LINES, FLOOR LINES, FURRED AREAS, SUSPENDED CEILINGS, STAIR STRINGERS, SHOWERS,
- 6. VERIFY MIN. 22"x30" FLOOR ACCESS. ATTIC ACCESS WITH 30" CLEARING ABOVE OPENING.

CHIMNEY ENCLOSURES, & MID HEIGHT OF WALLS OVER 10' IN HEIGHT.

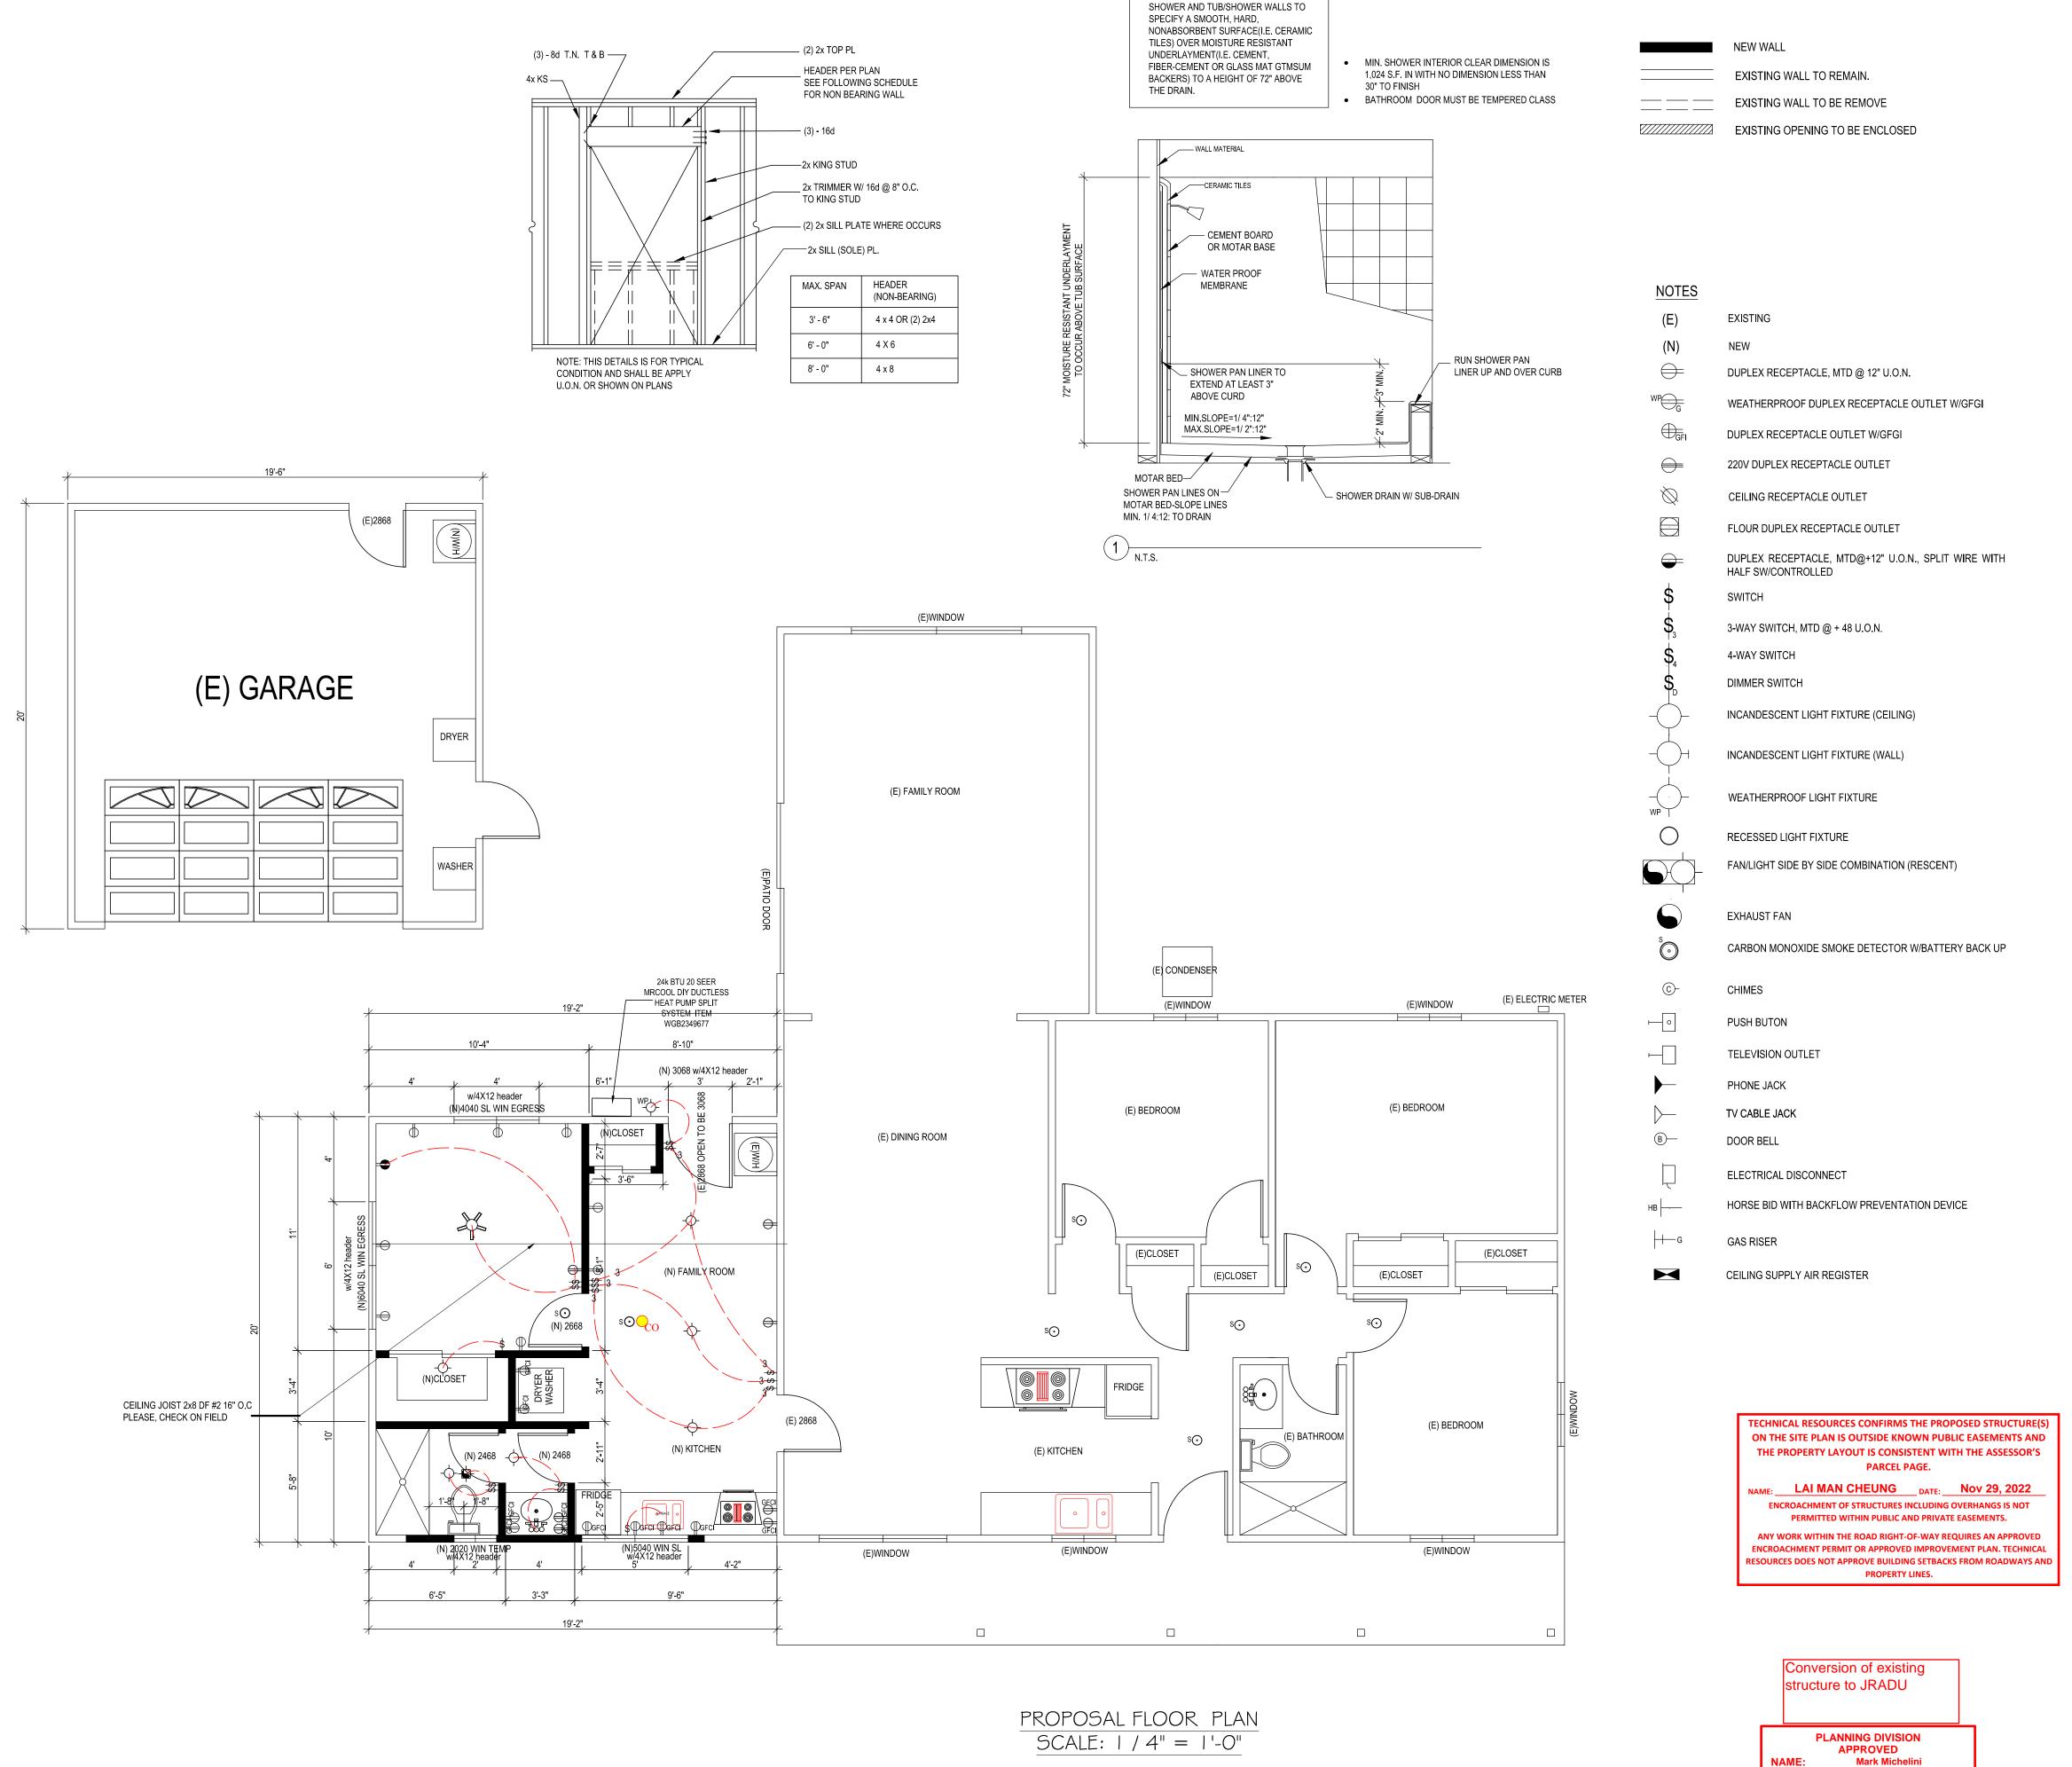
- 7. DOORS, WINDOWS, & SHOWER DOORS WITHIN HAZARDOUS AREAS TO BE
- 8. ALL POSTS, BEAMS & WALLS SUPPORTING THE FLOOR/ CEILING SHALL HAVE
- 9. ALL NEW WINDOWS AND GLASS SLIDING DOOR SHALL BE LOW-E DUAL GLAZED U.N.O.
- 10. MATERIAL GRADE STAMPS WILL BE CHECKED ON FRAME INSPECTION.
- 11. ALL CONSTRUCTION SHALL COMPLY WITH THE 2019 EDITION OF THE CBC, CMC, CPC, CEC, CRC AND CFC AND THE 2019 CALIFORNIA ENERGY CODE.
- 12. CHANGES FROM THE APPROVED PLANS DURING CONSTRUCTION OTHER THAN
  1.) CABINET CHANGES WHEN NOT BEING SUPPORTED ENTIRELY BY THE ROOF
  STRUCTURE, APPROVED PLAN, 2.) INTERIOR NON-STRUCTURAL WALL FINISHES;
  SHALL CAUSE PLAN APPROVAL AND CONSTRUCTION TO BE SUSPENDED.
  A NEW PLAN CHECK (FOR A NEW PLAN) SHOWING CHANGES WILL BE SUBMITTED
  FOR REVIEW AND APPROVAL THROUGH THE NORMAL PLAN CHECK PROCESS.
- 13. FIREBLOCKING WITH NON-COMBUSTIBLE MATERIAL SHALL BE PROVIDED IN OPENINGS AROUND VENTS, PIPES, DUCTS, FIREPLACES, AND SIMILAR OPENINGS PER CBC 708.2.1 (4).
- 14. PROVIDE SMOKE DETECTORS (HARDWIRED 110v W/BATT BACK-UP) IN EVERY BEDROOMS, THE HALL WAY TO THE BEDROOM, PROVIDE CARBON MONOXIDE SMOKE ALARM DETECTOR IN ALL SLEEPING ROOM.
- 15. IN EACH NEW BEDROOM, THERE IS AT LEAST ONE WINDOW, FOR EMERGENCY ESCAPE OR RESCUE: REQUIRE OPENING OF MINIMUM NET CLEAR AREA, 5.7 SQ. FT. HEIGHT 24", WIDTH 20", AND MAXIMUM FINISHED OPENING HEIGHT 44"ABOVE FINNISH FLOOR
- 16. NEW 3'X3' MIN, CONCRETE LANDING AT ALL NEW EXTERIOR DOOR. LANDING SHALL NOT BE LOWER THAN 7-1/2" FROM FLOOR LEVEL.
- 17. BATHROOM SLIDING DOOR MUST BE TEMPERED GLASS.
- 18. ALL NEW BEDROOM MUST BE AFCI CIRCUIT.
- 19. PRESSURE OR THERMOSTATIC MIXING VALVE AT THE SHOWERS AND TUBS, WHICH LIMIT WATER TEMPERATURE TO 120 DEGREES F
- 20. THE SHOWERS MUST HAVE INSIDE DEMENSION OF AT LEAST 30 INCHES, THE TOTAL FLOOR AREA OF A SHOWER MUST BE AT LIST 1,024 SQUARE INCHES, OPENING TO SHOWER MUST BE MIN. 24 INCHES WIDE, THE DOOR MUST BE TEMPERED GLASS.(SEE DETAILS)

# ELECTRICAL NOTES:

MOTION SENSOR WITH INTEGRAL PHOTOCONTROL

2. ALL HARDWIRED LIGHTING IN BATHROOMS, GARAGES, LAUNDRY AND UTILITY ROOMS MUST BE HIGH EFFICACY OR CONTROLLED BY A MANUAL-ON MOTION SENSOR

- 3. ALL HARDWIRED LIGHTING IN OTHER ROOMS (HALLWAYS, DINING ROOMS, FAMILY ROOMS AND BEDROOMS) SHALL BE HIGH EFFICACY OR CONTROLLED BY A MANUAL-ON OCCUPANT SENSOR OR A DIMMER MUST CONTROL IT
- 4. ALL SWITCHES ON A MULTIPLE SWITCHED CIRCUIT SHALL BE CONTROLLED




GRAPHIC DESIGN NOVEMBER 2022 AS SHOWN Drawn: WILLIAM TRAN & LUYEN HONG NGUYEN -mail: william\_t55@yahoo.com & helennguyen3689@gmail.co (408) 876-8402 & (916) 526-5881 Address: 9743 WHITE PINE WAY, ELK GROVE, CA 95624 1449 BOB WHITE PLACE, SAN JOSE, CA 95131 PLAN 95608 TRIC AND ELI CARMICH OOR WAY, PROPOSA 4109 RUTLE REVISION BY

> JOB **04/04/2023**

SHEET NO:

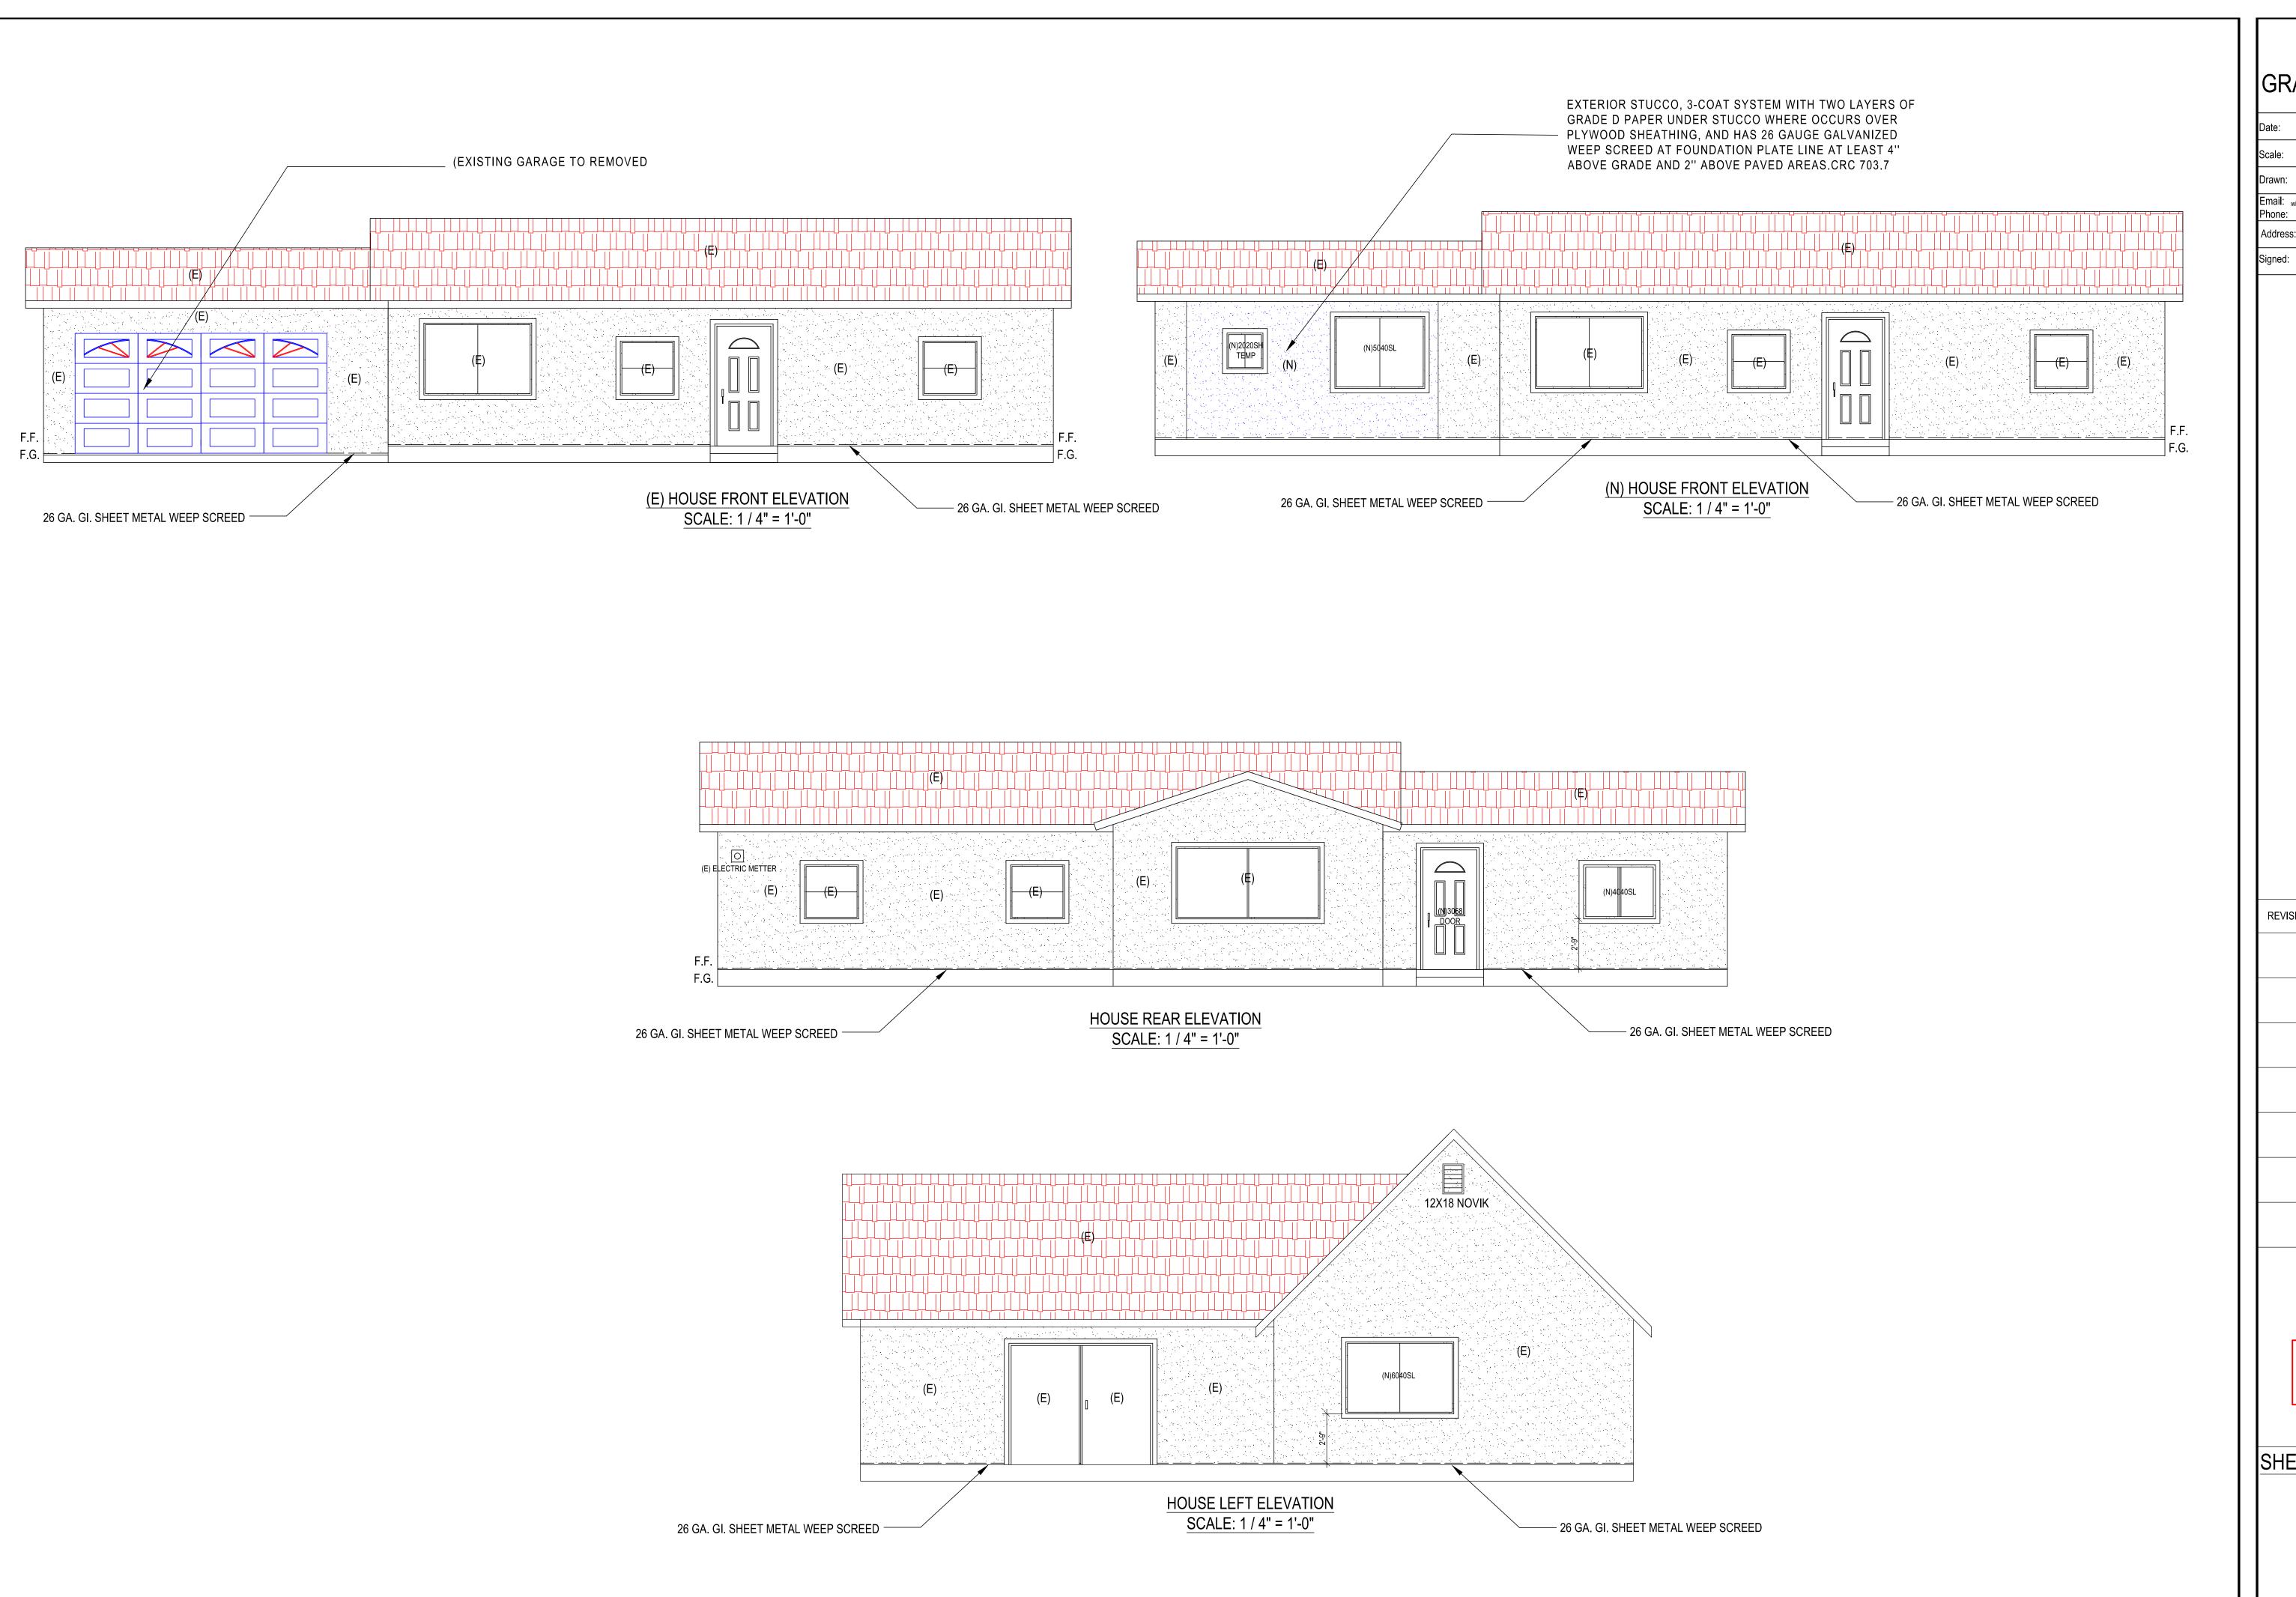11/29/2022

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