

# VINCENT DO'S RESIDENCE

## 236 ALDEN RD, HAYWARD, CA 94541



### PROJECT DATA - SITE PLAN

### VINCENT DO'S RESIDENCE

#### STRUCTURAL GENERAL NOTES

##### A. GENERAL

1. ALL WORK SHALL CONFORM TO CURRENT 2022 CBC, CBC, CMC, CPC, 2022 NEC, 2022 CEC. LAWS & ORDINANCES
2. THE CONTRACTOR SHALL VERIFY & BE RESPONSIBLE FOR ALL DIMENSIONS & CONDITIONS AT THE JOB SITE AND SHALL NOTIFY THE ARCHITECT OF ANY DISCREPANCIES BETWEEN ACTUAL CONDITIONS & WHAT IS SHOWN ON THE DRAWINGS BEFORE PROCEEDING WITH THE WORK.
3. ANY OMISSIONS OR CONFLICTS BETWEEN THE ARCHITECTURAL, STRUCTURAL & MECHANICAL DRAWINGS SHALL BE BROUGHT TO THE ATTENTION OF THE CITY INSPECTOR.
4. SHOP DRAWINGS REQUIRED BY THE SPECIFICATIONS SHALL BE SUBMITTED TO THE ARCHITECT PRIOR TO FABRICATION, & ALLOW REASONABLE TIME FOR REVIEW AND APPROVAL BY THE STRUCTURAL ENGINEER.
5. THE CONTRACTOR SHALL BE RESPONSIBLE FOR THE SAFETY OF THE BUILDING DURING THE CONSTRUCTION. THE CONTRACTOR SHALL PROVIDE ADEQUATE SHORING, BRACING & GUYS IN ACCORDANCE WITH ALL NATIONAL, STATE AND LOCAL SAFETY ORDINANCES. ANY DEVIATIONS MUST BE APPROVED PRIOR TO ERECTION.
6. ALL CONDITIONS NOT CLEARLY SHOWN OR DETAILED SHALL BE OF THE SAME TYPE & CHARACTER AS THOSE SHOWN FOR SIMILAR CONDITIONS.

##### B. FOUNDATION

1. FOUNDATION EXCAVATIONS SHALL BE FREE OF LOOSE MATERIAL PRIOR TO THE PLACEMENT OF ANY REINFORCING STEEL OR CONCRETE.

##### C. CONCRETE

1. ALL CONCRETE SHALL HAVE A MINIMUM COMPRESSIVE STRENGTH OF 2500 PSI AT 28 DAYS.
2. CONCRETE SHALL BE REGULAR WEIGHT HARD ROCK TYPE (150#CF) & AGGREGATE SHALL CONFORM TO ASTM C33 U.O.N.
3. CEMENT SHALL CONFORM TO ASTM C150, TYPE 1 OR 2.
4. PLACEMENT OF CONCRETE SHALL BE IN CONFORMANCE WITH ACI 301.
5. CONCRETE SHALL BE MACHINE MIXED AND DELIVERED IN ACCORDANCE WITH ASTM C-94. SUBMIT MIX DESIGN TO THE ARCHITECT FOR APPROVAL PRIOR TO PLACING CONCRETE.
6. PROVIDE MINIMUM CLEAR COVER OF CONCRETE OVER REINFORCING AS FOLLOWS

##### D. REINFORCING STEEL

1. ALL REINFORCING STEEL SHALL CONFORM TO ASTM SPECIFICATION A615 GRADE 60 FOR #5 AND LARGER BARS AND GRADE 40 FOR #3 & #4.
2. ALL REINFORCING STEEL SHALL BE LAPPED AS NOTED BELOW. #4: 24" FOR BOTTOM BARS AND 28" FOR TOP BARS; #5: 30" FOR BOTTOM BARS AND 35" FOR TOP BARS; #6: 40" FOR BOTTOM BARS AND 46" FOR TOP BARS AT SPLICES UNLESS OTHERWISE NOTED ON PLANS. SPLICES SHALL BE LOCATED AS DETERMINED IN THE PLANS. STAGGER ALL LAPS SPLICES.
3. WELDED WIRE FABRIC SHALL CONFORM TO ASTM A82 AND A185.
4. ANCHOR BOLTS, DOWELS AND OTHER EMBEDDED ITEMS SHALL BE SECURELY TIED IN PLACE BEFORE CONCRETE IS PLACED, USE CYT THREAD ANCHOR BOLTS ONLY.

##### E. STRUCTURAL & MISC. STEEL



1. FABRICATION AND ERECTION TO BE IN ACCORDANCE WITH LATEST AISC SPECIFICATIONS. STRUCTURAL STEEL SHALL BE ASTM A36, EXCEPT TUBE COLUMNS WHICH ARE ASTM A500, GRADE B.
2. WELDING TO BE IN ACCORDANCE WITH AWS SPECIFICATIONS. WELDING SHALL BE PERFORMED BY CERTIFIED WELDERS USING E77XX ELECTRODES.
3. ALL PLATES, ETC., TO BE BOLTED TO CONCRETE ELEMENTS, SHALL NOT BE FABRICATED UNTIL THE BOLTS HAVE BEEN LOCATED IN THE FIELD.
4. BOLTS SHALL BE ASTM A307 TYPE. THREADS MAY BE INCLUDED IN THE SHEAR PLANES
5. STEEL TO BE SHOP PRIMED FOR, EXCEPT WHERE EMBEDDED IN CONCRETE OR TO BE WELDED.
6. ALL WELDING SHALL BE CONTINUOUSLY INSPECTED BY AN INDEPENDENT INSPECTOR APPROVED BY THE BUILDING DEPARTMENT.

##### F. WOOD FRAME CONSTRUCTION

1. GENERAL WOOD FRAMING: WOOD FRAMING THROUGHOUT THE BUILDING SHALL BE CONSTRUCTED IN ACCORDANCE WITH CALIFORNIA BUILDING CODE (2019) AND THE STANDARD PRACTICES RECOMMENDED BY AMERICAN INSTITUTE OF TIMBER CONSTRUCTION AND WCLA GRADING. FOR NAILING SEE SECTION J. BOLTS IN WOOD FRAMING SHALL BE STANDARD MACHINE BOLTS WITH STANDARD MALLEABLE IRON WASHERS.
3. WOOD PLATES: BEARING DIRECTLY UPON CONCRETE SHALL BE P.T.D.F.
4. UNLESS OTHERWISE NOTED ON DRAWINGS OR IN SPECIFICATIONS, FRAMING MEMBERS SHALL HAVE THE FOLLOWING GRADING:



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BLD2023-02832  
Damien Curry

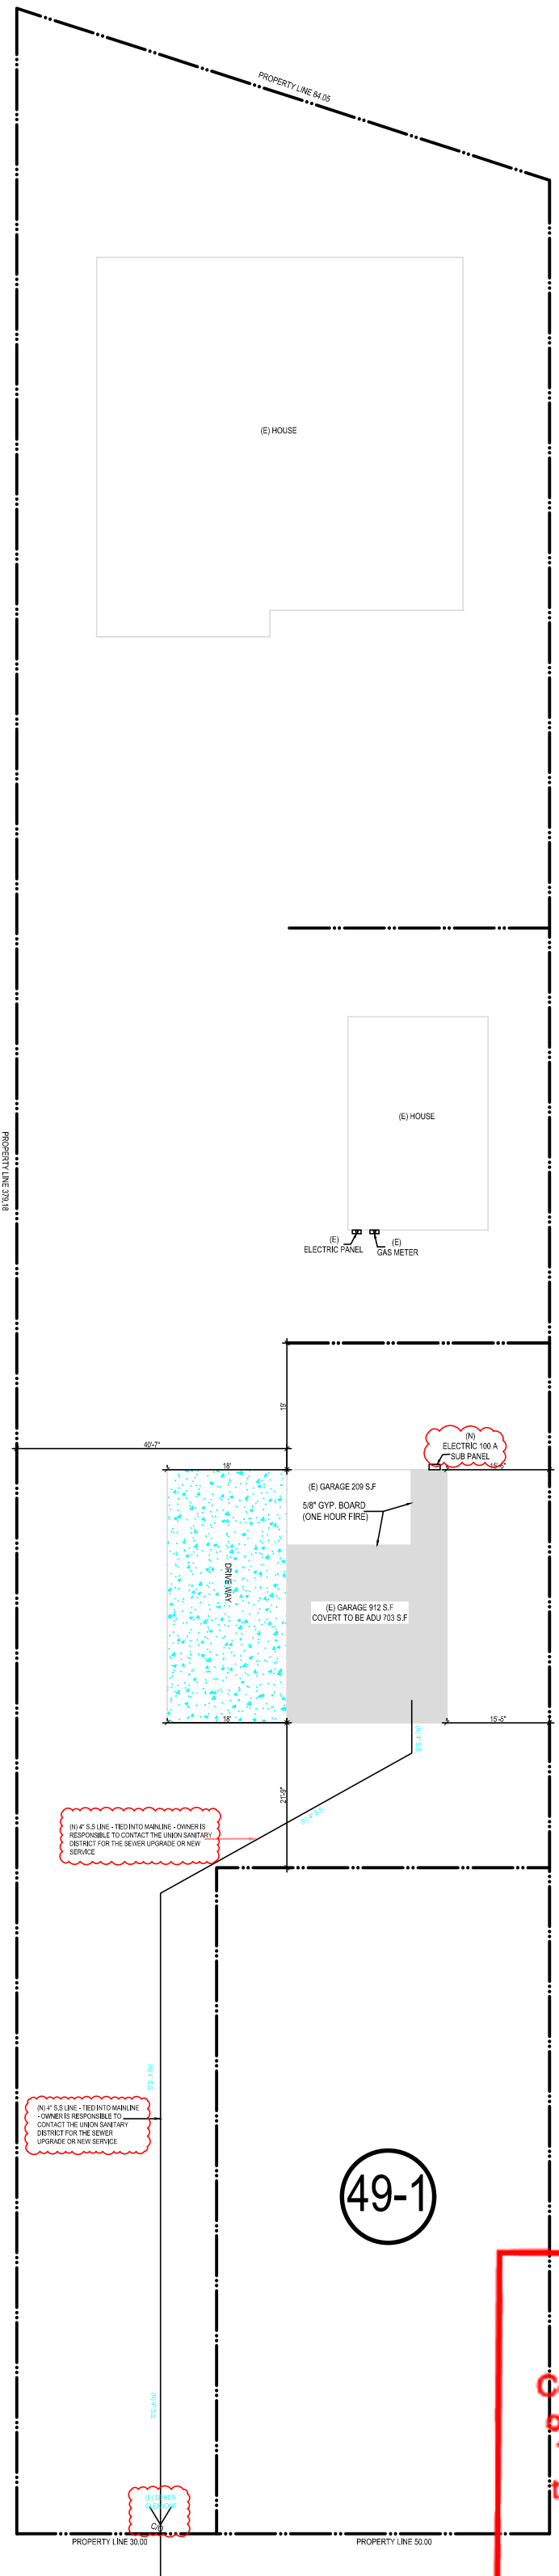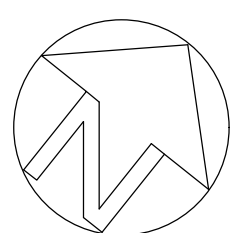


SITE PLAN  
NOT TO SCALE

**Alameda County Building Division Notes:**  
**Review and approved of any proposals, plans or other submissions associated therewith, shall in no way be deemed to satisfy or comply with any applicable Conditions, Covenants and Restrictions (CC&Rs).**

**Applicants are responsible for contacting their Homeowner Associations (if any) to ensure compliance with CC&Rs**

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BLD2023-02832  
Kevin Zhang

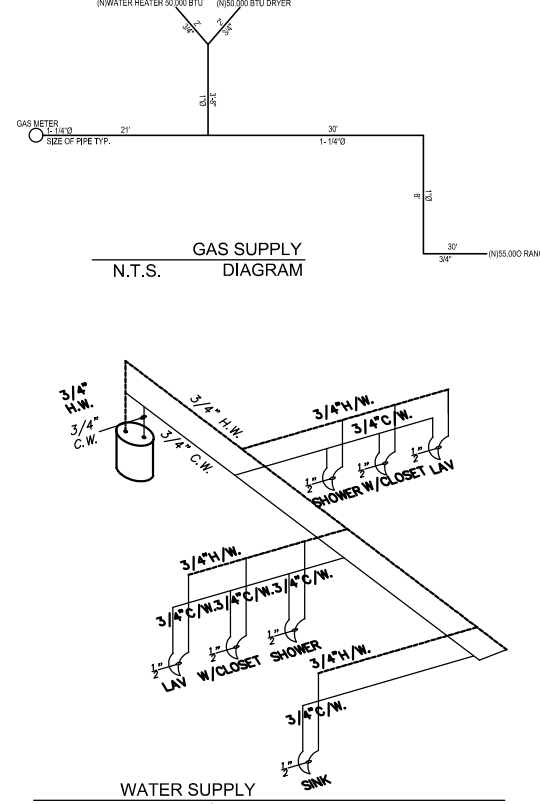

AD2

**REVIEWED**  
**ALAMEDA COUNTY PUBLIC WORKS AGENCY**  
**BUILDING INSPECTION DEPARTMENT**  
**Construction shall not be changed from what is shown, on this plan unless authorized by the Building Official. This plan shall be kept at the building site for use by the Building Inspector. Do not mark or alter this plan. Affixing of this stamp on these plans shall not be interpreted as permission to violate or omit any provisions of the adopted codes of any other law, rule, or regulation that is applicable to this construction project.**

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Kevin Zhang

#### PROJECT DATA

OWNER: VINCENT DO  
EXISTING USE: SINGLE FAMILY RESIDENCE  
LOCATION: 236 ALDEN RD, HAYWARD, CA 94541  
APN: 413-0047-049-02  
ZONING: R3  
LOT GROSS SIZE: 0.5 ACRES = 22,216 S.F.  
OCCUPANCY GROUP: R-3  
TYPE OF CONSTRUCTION: V-B  
FIRE SPRINKLER: NONE  
YEAR BUILT: 1980  
ALLOWABLE FLOOR AREA: 0.51 ACRES = 22,216 S.F.  
LOT AVERAGE SLOPE: (FLAT)  
FLOOR AREA: EXISTING PROPOSAL TOTAL  
DWELLING: 2,700 S.F. 2,700 S.F.  
GARAGE: 912 S.F. 912 S.F.  
TOTAL FOOTPRINT: 2,700 S.F.  
FAR: 1,1%

#### SCOPE OF WORK

CONVERSION OF EXISTING GARAGE INTO ADU:  
TOTAL EXISTING GARAGE AREA: 912 S.F.  
AREA TO BE CONVERTED TO ADU: 703 S.F.  
ADU SPECIFICATIONS:  
. BEDROOMS: 2  
. BATHROOMS: 2  
. LIVING ROOM: 1  
. KITCHEN: 1

#### STRUCTURAL GENERAL NOTES

##### G. NAIL SCHEDULE

1. WOOD MEMBERS SHALL BE CONNECTED WITH NAILING INDICATED IN TABLE 2304.9.1 OF 2022 CBC UNLESS GREATER SIZES AND NUMBER OF NAILS ARE SHOWN OR NOTED ON DRAWINGS; NAILS EXPOSED TO WEATHER SHALL BE GALVANIZED; NAILS SHALL BE COMMON WIRE NAILS; HOLES FOR NAILS SHALL BE PROVIDED WHERE THE WOOD TENDS TO SPLIT; SPLIT WOOD MEMBERS SHOULD BE REPLACED AND REMOVED FROM THE JOB PROMPTLY. SHORT PLYWOOD NAILS FOR EQUIVALENT SHEAR VALUE MAY BE USED. SEE PLANS FOR NAIL SPACING. NAIL ROOF SHEATHING 8d @ 6" O.C. AT SUPPORTED EDGES. 8d @ 10" INCHES O.C. AT INTERMEDIATE SUPPORTS. FLOOR SHEATHING 8d @ 6" O.C. AT BOUNDARIES AND PANEL EDGES AND 8d @ 10" O.C. AT INTERMEDIATE SUPPORTS. PLYWOOD WALL SHEATHING SHALL BE NAILED PER SHEAR WALL SCHEDULE AT SHEAR WALLS, AND AT A MINIMUM OF 8d @ 6" O.C. ALL OTHER EDGES.
2. AT PRESSURE TREATED LUMBER USE HOT-DIPPED GALVANIZED, STAINLESS STEEL, SILICON BRONZE, OR COPPER.

##### G. FIRE SPRINKLES




ALL CONSTRUCTION SITES MUST COMPLY WITH APPLICABLE PROVISION OFF THE CFC CHAPTER 14 AND OUR STANDARD DETAIL AND SPECIFICATION SI-7

#### APPLICABLE CODES

##### CODE COMPLIANCE

ALL CONSTRUCTION SHALL CONFORM TO ALL GOVERNING LAWS, CODES AND ORDINANCES INCLUDING BUT NOT LIMITED TO THE FOLLOWING:  
-2022 CALIFORNIA BUILDING CODES: CBC, CMC, CPC, CFC & CEC, CRC.  
-2022 CA ENERGY CODE  
-ALAMEDA COUNTY MUNICIPAL CODE  
-ALL LOCAL ORDINANCES

#### VICINITY MAP

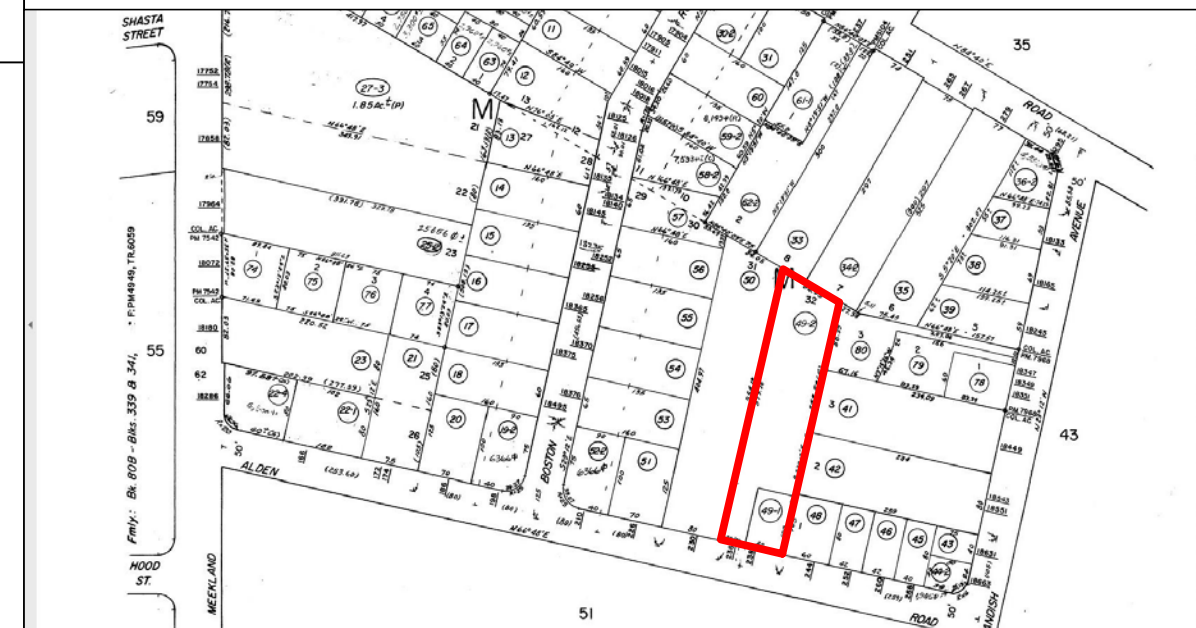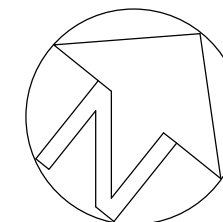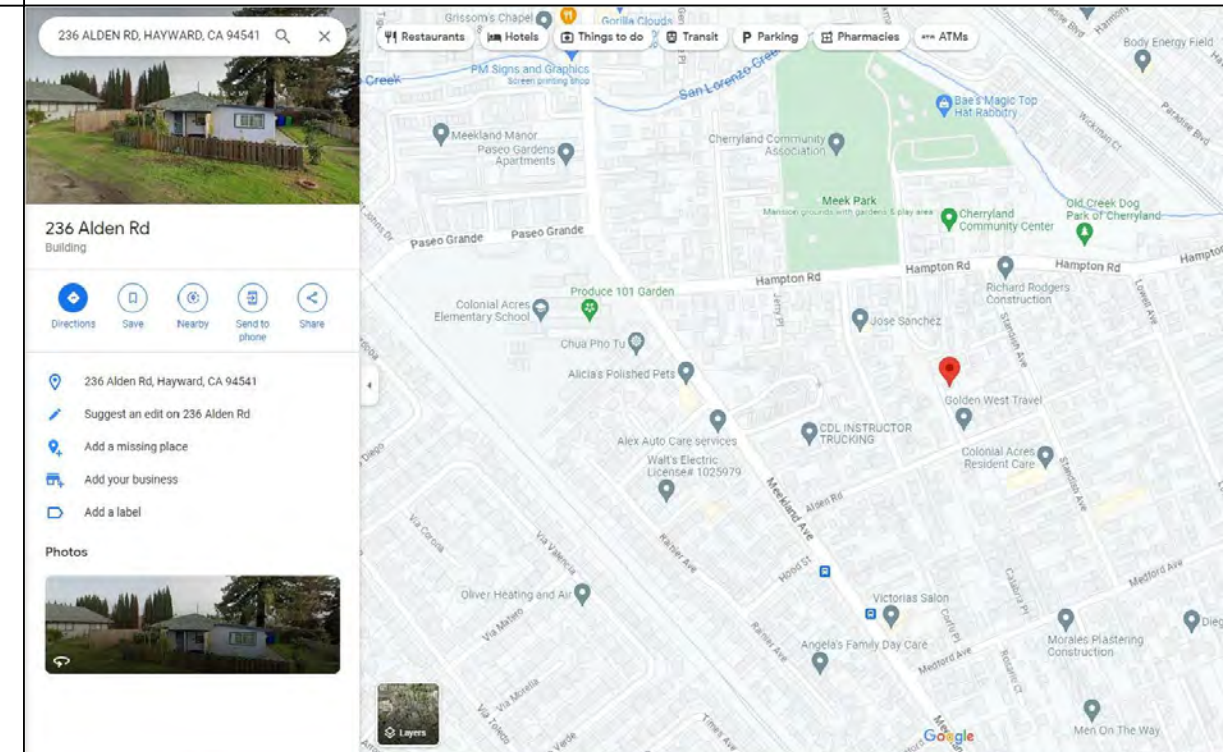

#### SHEET IN DEX

##### ARCHITECTURE

- |     |                                  |
|-----|----------------------------------|
| A-1 | SITE PLAN, SUMMARY, NOTES, AREA  |
| A-2 | PROPOSAL FLOOR AND ELECTRIC PLAN |
| A-3 | ELEVATIONS PLANS                 |
| A-4 | FOUNDATION & DETAILS             |
| A-5 | ROOF FRAMING PLAN & DETAILS      |
| A-6 | T-24 ENERGY REPORT               |
| A-7 | CG-1 CAL GREEN MANDATORY         |
| A-8 | CG-2 CAL GREEN MANDATORY         |

#### NOTES

- a) Please note that a Building Permit cannot be issued until all clearances by all reviewing departments ( listed above) have been approved on the project. Check the status of your permit by visiting [www.sipermits.org](http://www.sipermits.org) and contact the individual departments directly with any questions.
- b) Revised plans, when required, must be clouded with delta number with a revision mark at each location where revision has occurred and be noted that additional comments may be triggered once revised plan are reviewed.
- c) When comments cite a section of code and require a revision, correction or amendment to plans, required information shall be specifically & directly provided on plans. Generic references to code section(s) is not acceptable.

REVISION	BY

Date: JULY 2023

Scale: AS SHOWN

Drawn: LUYEN HONG NGUYEN

Signed: *Thuy*

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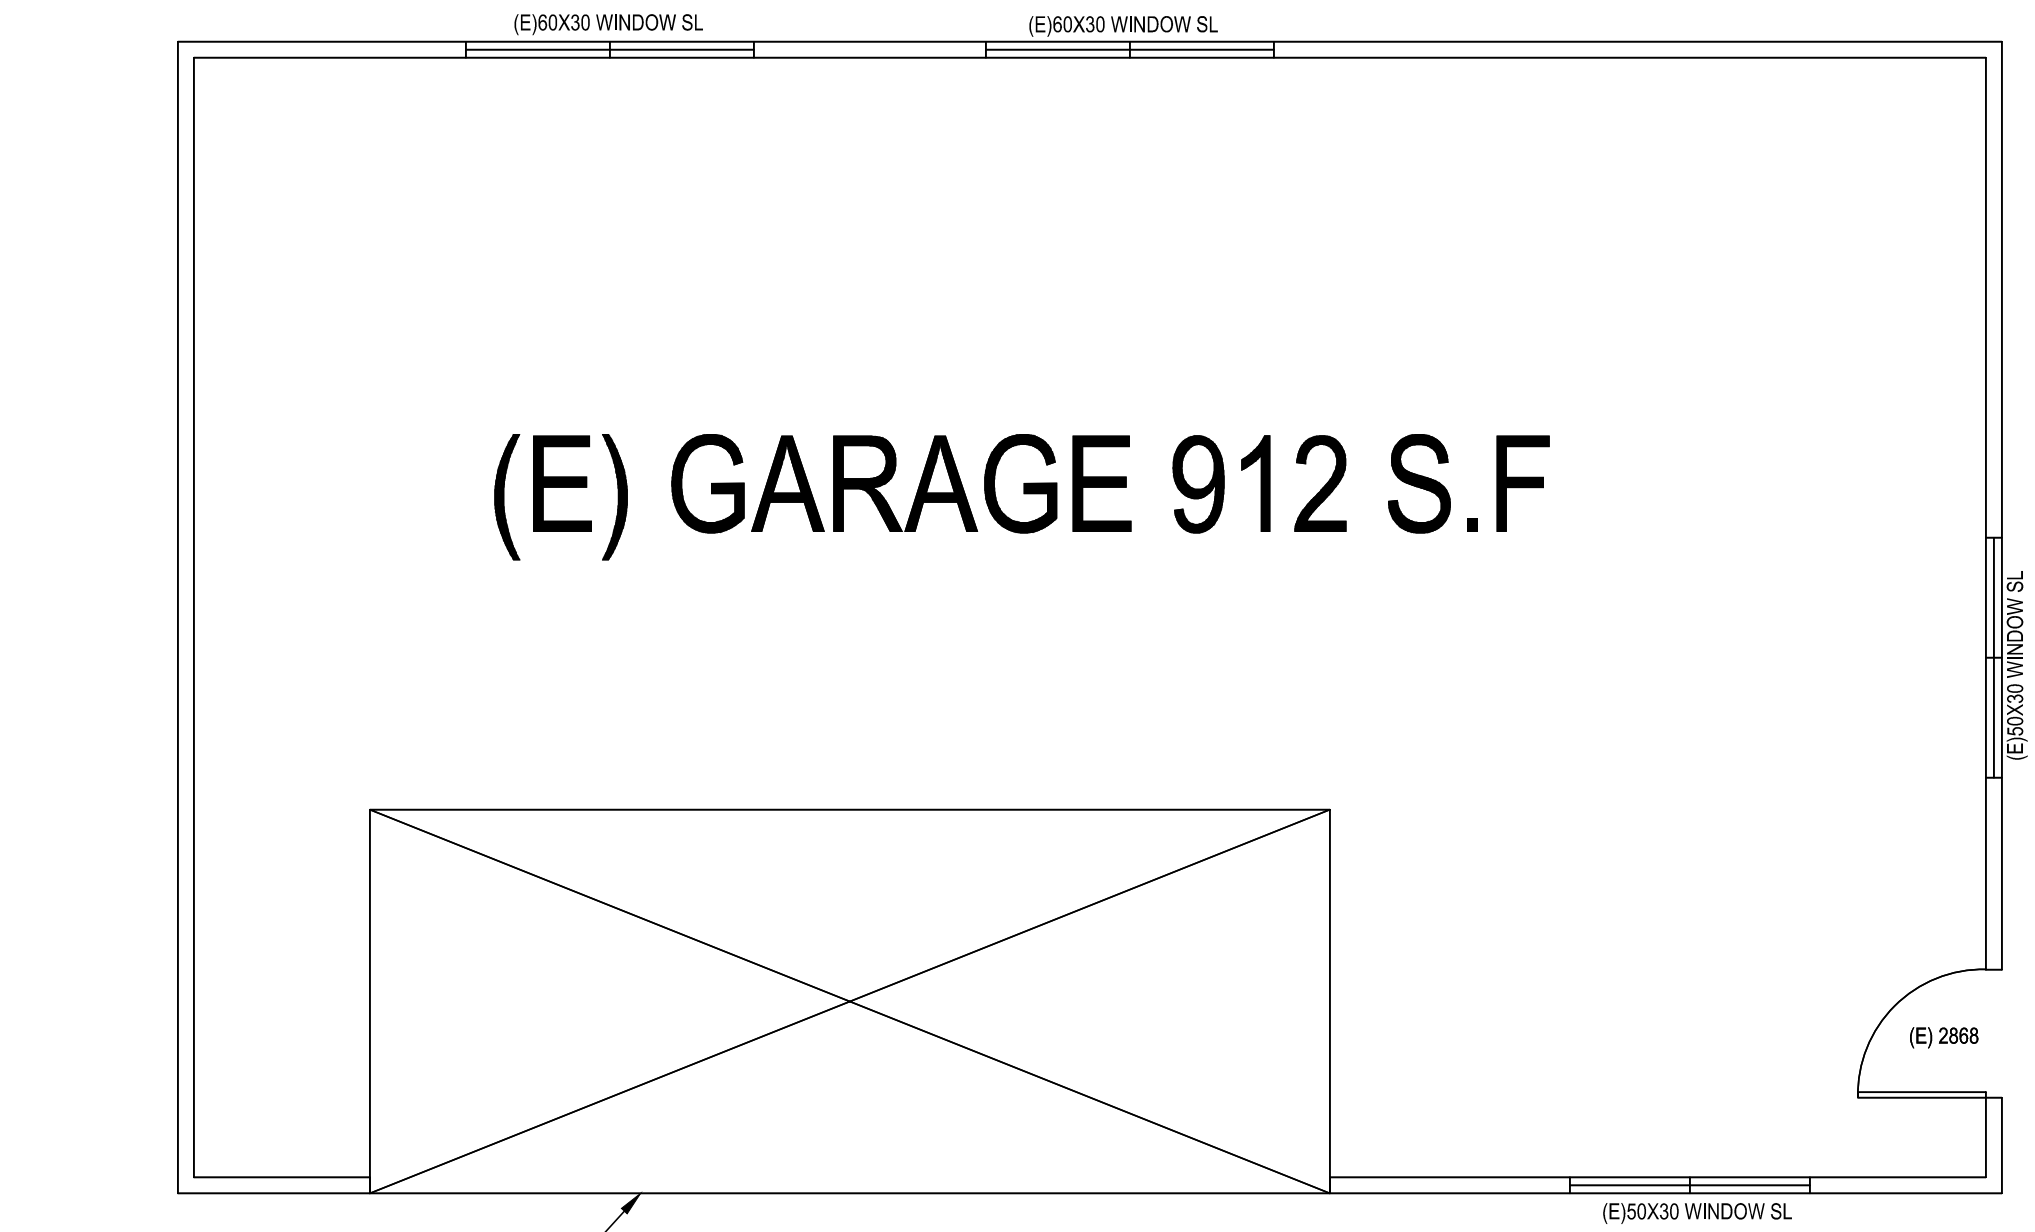
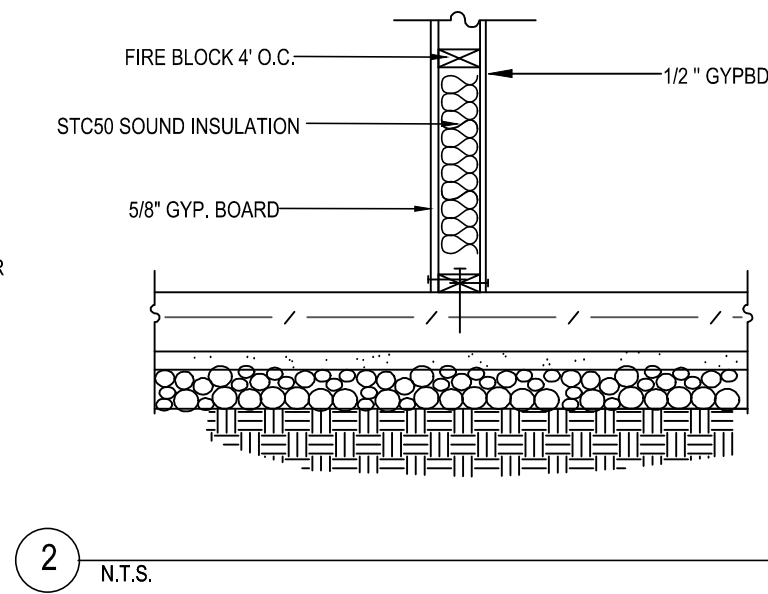
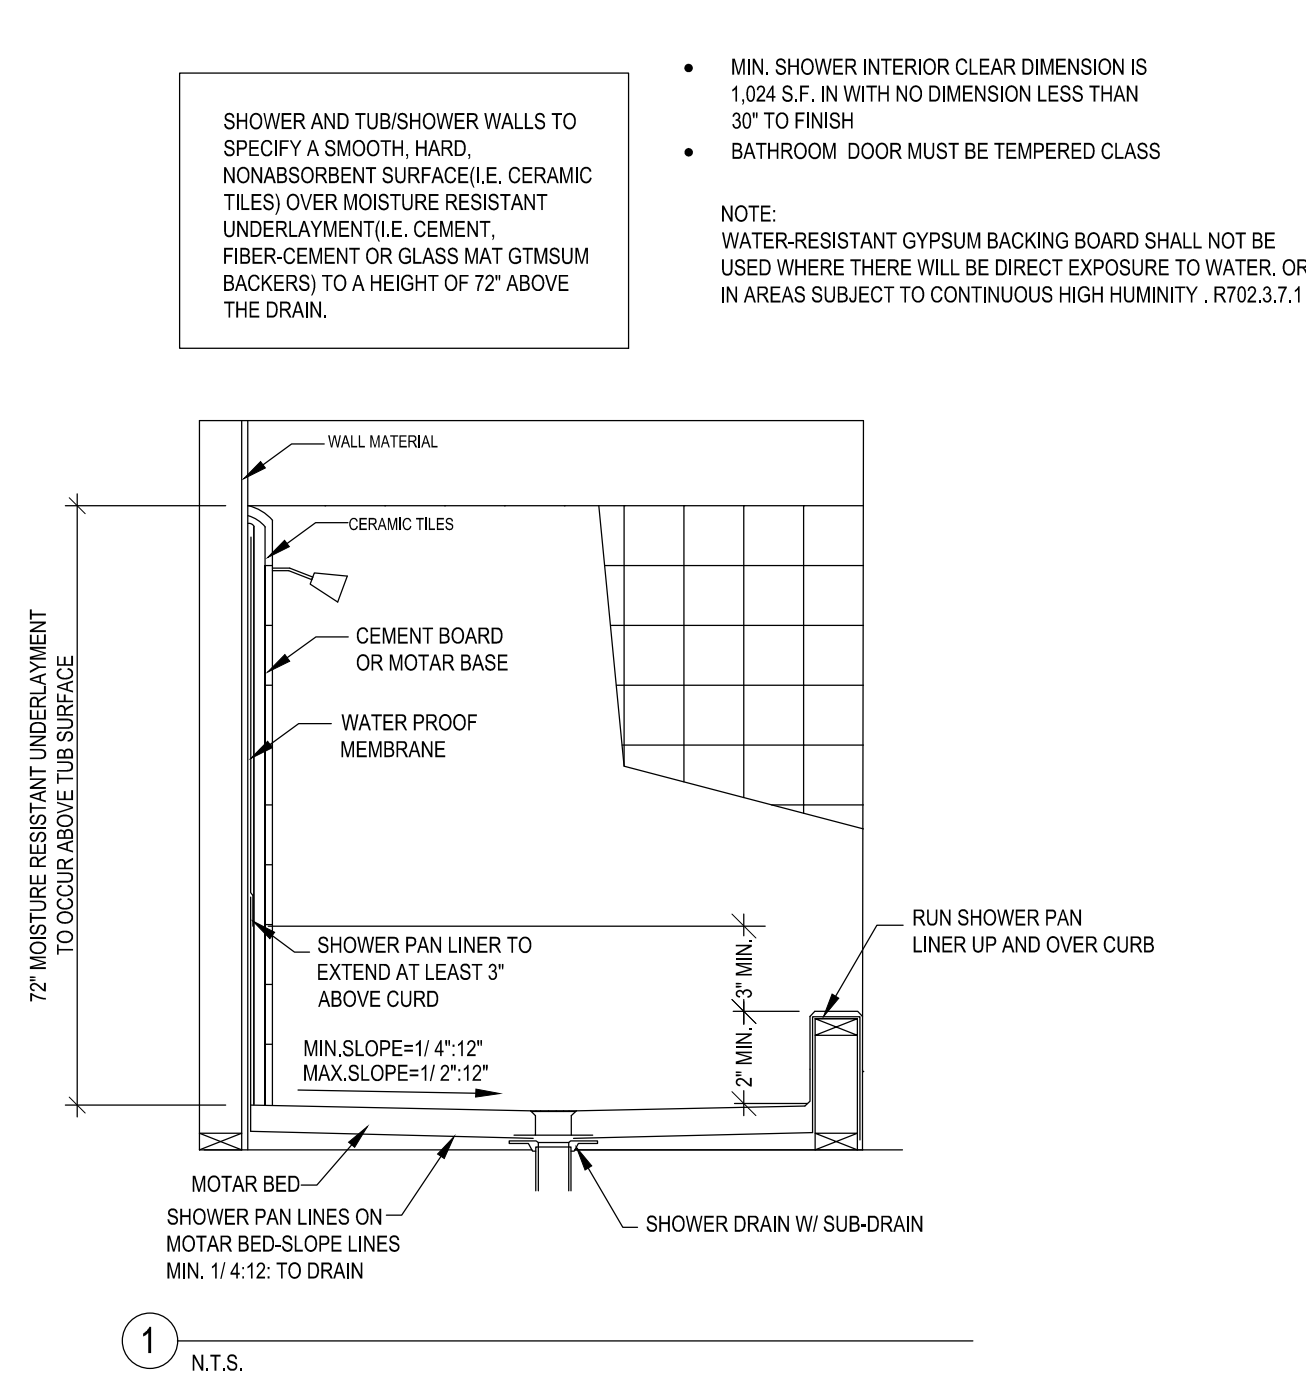
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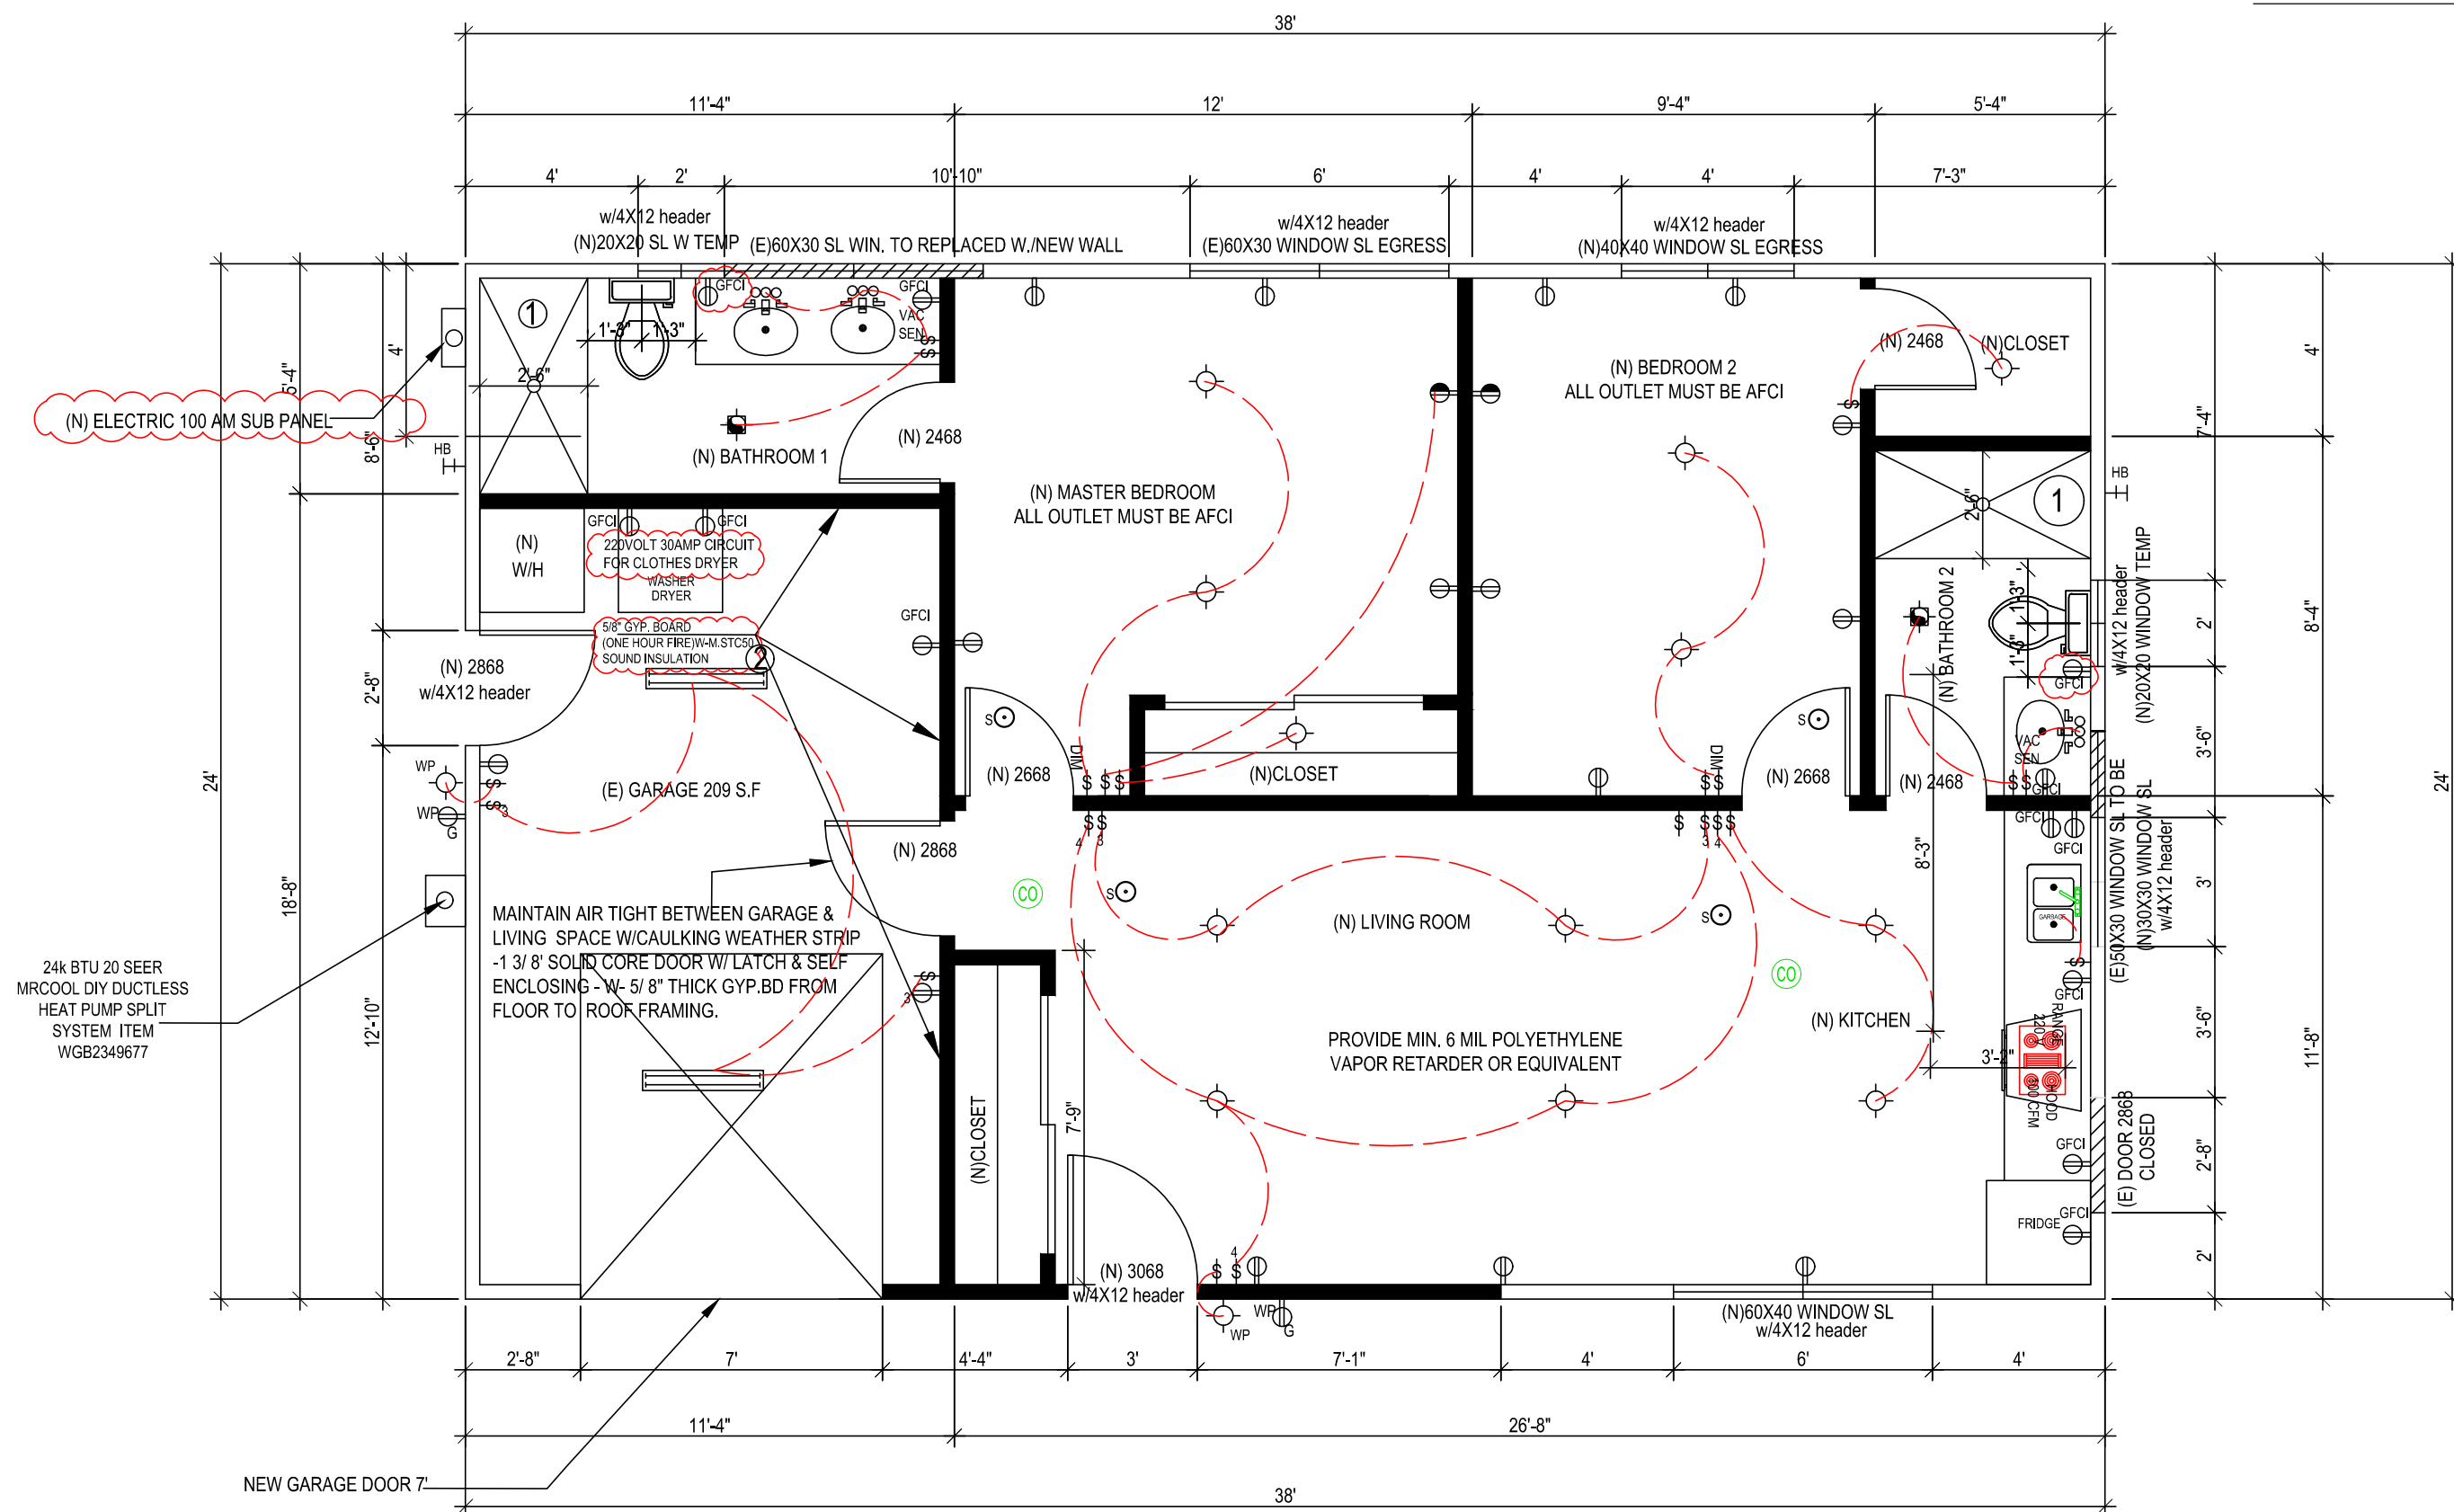
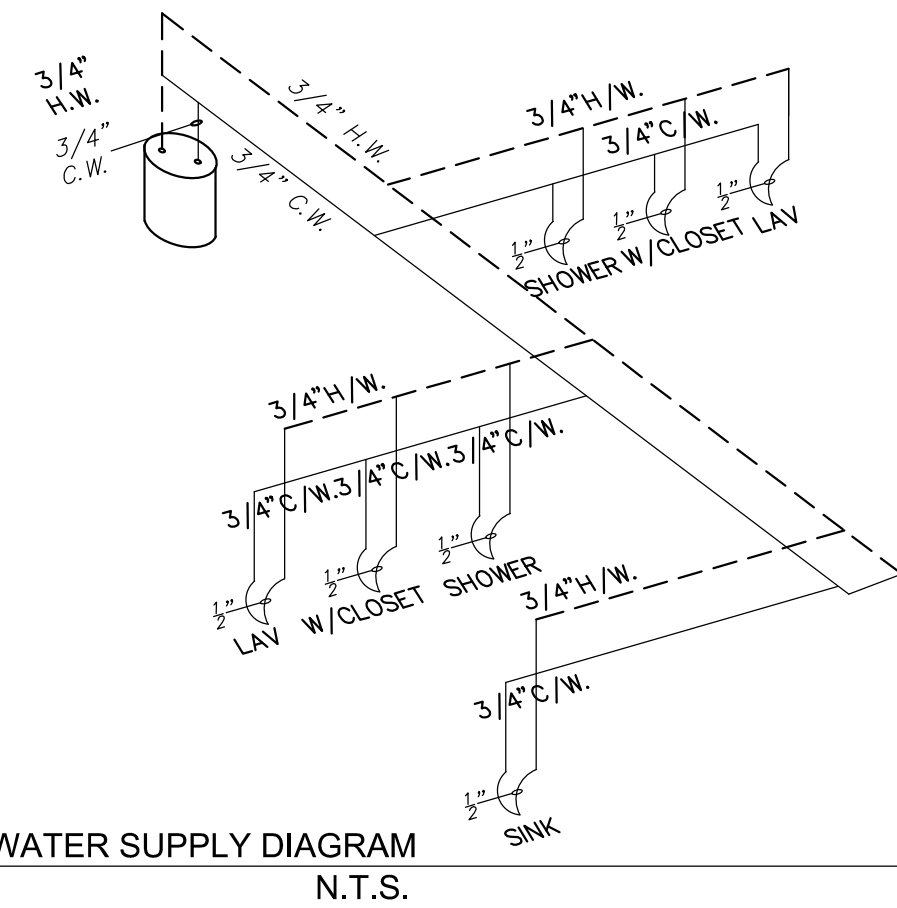
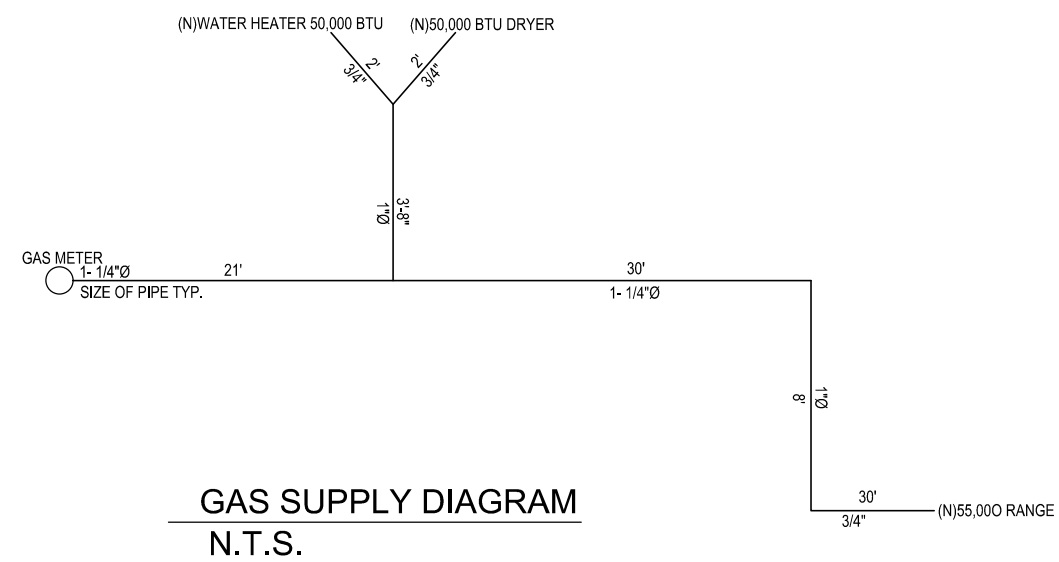
2. ALL CONCRETE TO BE POURED ON UNDISTURBED SOIL.
2. ALL LUMBER IN CONTACT WITH CONCRETE SHALL BE FOUNDATION GRADE RWD OR PRESSURE TREATED.
3. ALL LUMBER USED IN CONSTRUCTION LOCATED NEARER THAN 8" TO EARTH SHALL BE F.G. RWD OR P.T.
4. PROVIDE SOLID BLOCKING FOR ALL PONY WALLS LESS THAN 14" HIGH
5. PROVIDE FIRESTOPS @ CONCEALED DRAFT OPENING, CEILING LINES, FLOOR LINES, FURRED AREAS, SUSPENDED CEILINGS, STAIR STRINGERS, SHOWERS, CHIMNEY ENCLOSURES, & MID HEIGHT OF WALLS OVER 10' IN HEIGHT.
6. VERIFY MIN. 22"x30" FLOOR ACCESS, ATTIC ACCESS WITH 30" CLEARING ABOVE OPENING.
7. DOORS, WINDOWS, & SHOWER DOORS WITHIN HAZARDOUS AREAS TO BE TEMPERED.
8. ALL POSTS, BEAMS & WALLS SUPPORTING THE FLOOR/ CEILING SHALL HAVE ONE-HOUR FIRE PROTECTION.
9. ALL NEW WINDOWS AND GLASS SLIDING DOOR SHALL BE LOW-E DUAL GLAZED U.N.O.
10. MATERIAL GRADE STAMPS WILL BE CHECKED ON FRAME INSPECTION.
11. ALL CONSTRUCTION SHALL COMPLY WITH THE 2019 EDITION OF THE CBC, CMC, CPC, CEC, CRC AND CFC AND THE 2019 CALIFORNIA ENERGY CODE.
12. CHANGES FROM THE APPROVED PLANS DURING CONSTRUCTION OTHER THAN:  
1.) CABINET CHANGES WHEN NOT BEING SUPPORTED ENTIRELY BY THE ROOF STRUCTURE, APPROVED PLAN, 2.) INTERIOR NON-STRUCTURAL WALL FINISHES; SHALL CAUSE PLAN APPROVAL AND CONSTRUCTION TO BE SUSPENDED.  
A NEW PLAN CHECK (FOR A NEW PLAN) SHOWING CHANGES WILL BE SUBMITTED FOR REVIEW AND APPROVAL THROUGH THE NORMAL PLAN CHECK PROCESS.
13. FIRELOCKING WITH NON-COMBUSTIBLE MATERIAL SHALL BE PROVIDED IN OPENINGS AROUND VENTS, PIPES, DUCTS, FIREPLACES, AND SIMILAR OPENINGS PER CBC 708.2.1 (4).
14. PROVIDE SMOKE DETECTORS (HARDWIRED 110v W/BATT BACK-UP) IN EVERY BEDROOM, THE HALL WAY TO THE BEDROOM, VENTILATED CARBON MONOXIDE SMOKE ALARM DETECTOR IN ALL SLEEPING ROOM.
15. IN EACH NEW BEDROOM, THERE IS AT LEAST ONE WINDOW, FOR EMERGENCY ESCAPE OR RESCUE: REQUIRE OPENING OF MINIMUM NET CLEAR AREA, 5.7 SQ. FT, HEIGHT 24", WIDTH 20", AND MAXIMUM FINISHED OPENING HEIGHT 44" ABOVE FINISH FLOOR
16. NEW 3'X3' MIN. CONCRETE LANDING AT ALL NEW EXTERIOR DOOR. LANDING SHALL NOT BE LOWER THAN 1'-1/2" FROM FLOOR LEVEL.
17. BATHROOM SLIDING DOOR MUST BE TEMPERED GLASS.
18. ALL NEW BEDROOM MUST BE AFCI CIRCUIT.
19. PRESSURE OR THERMOSTATIC MIXING VALVE AT THE SHOWERS AND TUBS, WHICH LIMIT WATER TEMPERATURE TO 120 DEGREES F
20. THE SHOWERS MUST HAVE INSIDE DIMENSION OF AT LEAST 30 INCHES, THE TOTAL FLOOR AREA OF A SHOWER MUST BE AT LIST 1,024 SQUARE INCHES, OPENING TO SHOWER MUST BE MIN. 24 INCHES WIDE, THE DOOR MUST BE TEMPERED GLASS.(SEE DETAILS)

1. MOTION SENSOR WITH INTEGRAL PHOTOCONTROL
2. ALL HARDWIRED LIGHTING IN BATHROOMS, GARAGES, LAUNDRY AND UTILITY ROOMS MUST BE HIGH EFFICACY OR CONTROLLED BY A MANUAL-ON MOTION SENSOR
3. ALL HARDWIRED LIGHTING IN OTHER ROOMS (HALLWAYS, DINING ROOMS, FAMILY ROOMS AND BEDROOMS) SHALL BE HIGH EFFICACY OR CONTROLLED BY A MANUAL-ON OCCUPANT SENSOR OR A DIMMER MUST CONTROL IT
4. ALL SWITCHES ON A MULTIPLE SWITCHED CIRCUIT SHALL BE CONTROLLED BY THE DIMMER SWITCH ON THAT CIRCUIT
5. ALL RECESSED FIXTURES SHALL BE LABELED AS BEING CERTIFIED TO HAVE A LEAKAGE RATING OF LESS THAN 2.0 AT 75 PASCAL
6. ALL HIGH EFFICACY FIXTURES AND NON-HIGH EFFICACY FIXTURES SHALL BE SWITCHED SEPARATELY
7. SMOKE DETECTOR SYSTEM SHALL BE HARD-WIRED, INTERCONNECTED TO SOUND SIMULTANEOUSLY AND EQUIPPED WITH BATTERY BACK UP.
8. MIN. 50% OF WATTAGE OF LIGHTS IN KITCHEN SHALL BE HIGH EFFICACY AND THOSE THAT ARE NOT SHALL BE SWITCHED SEPARATELY
9. LIGHTS MOUNTED TO EXTERIOR OF BUILDING SHALL BE HIGH EFFICACY OR ON A PHOTO CONTROL/MOTION SENSOR COMBINATION

LAMP POWER RATING:	MINIMUM LAMP EFFICACY:
15 watts or less	40 lumens per watt
over 15 watts to 40 watts	50 lumens per watt
over 40 watts	60 lumens per watt



(E) FLOOR PLAN  
SCALE: 1 / 4" = 1'-0"



(N)PROPOSAL FLOOR PLAN AND ELECTRIC PLAN  
SCALE: 1 / 4" = 1'-0"



Date: JULY 2023

Scale: AS SHOWN

Drawn: LUYEN HONG NGUYEN

Signed: *Thumy*

PROPOSAL FLOOR AND ELECTRIC PLAN  
236 ALDEN RD, HAYWARD, CA 94541



REVISION	BY
<p>ED</p> <p>IC WORKS AGENCY</p> <p>IN DEPARTMENT</p> <p>anged from what is shown, by the Building Official.</p> <p>building site for use by a mark or alter this plan.</p> <p>ese plans shall not be to violate or omit any s of any other law, rule, or this construction project.</p>	
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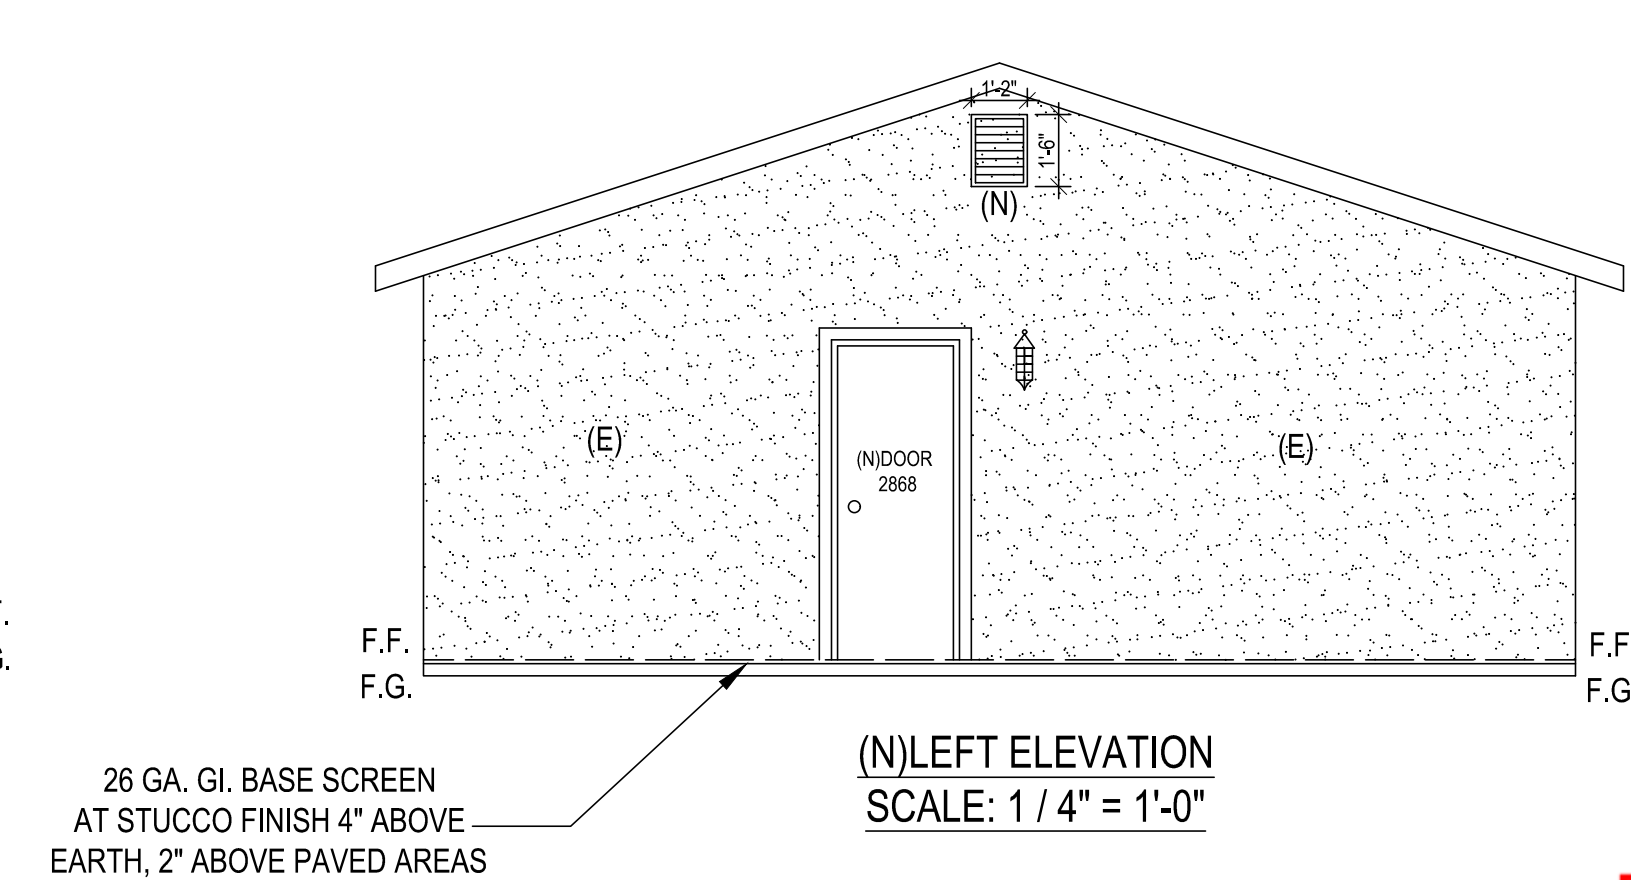
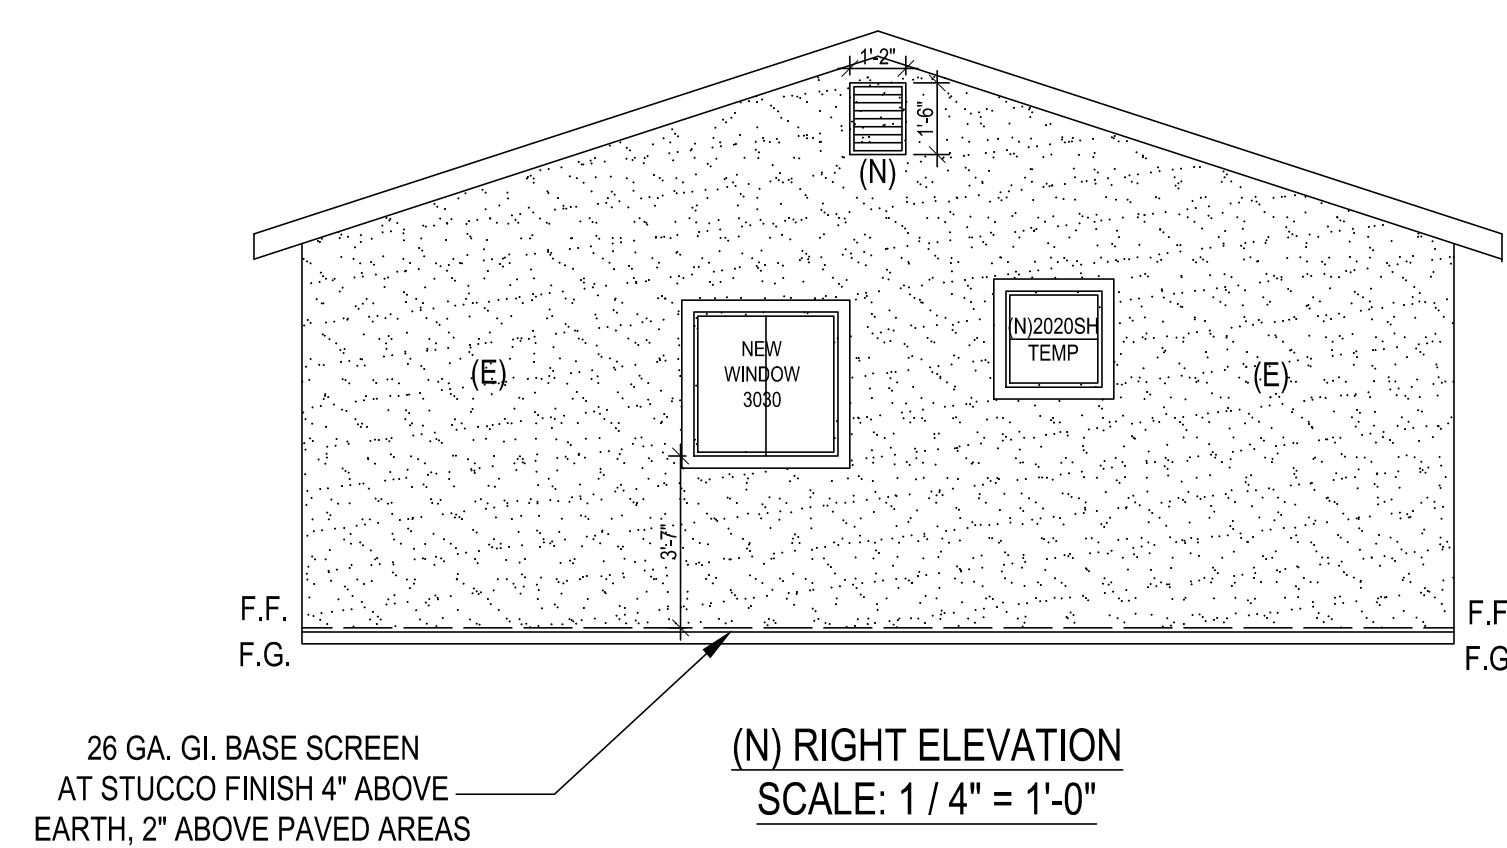
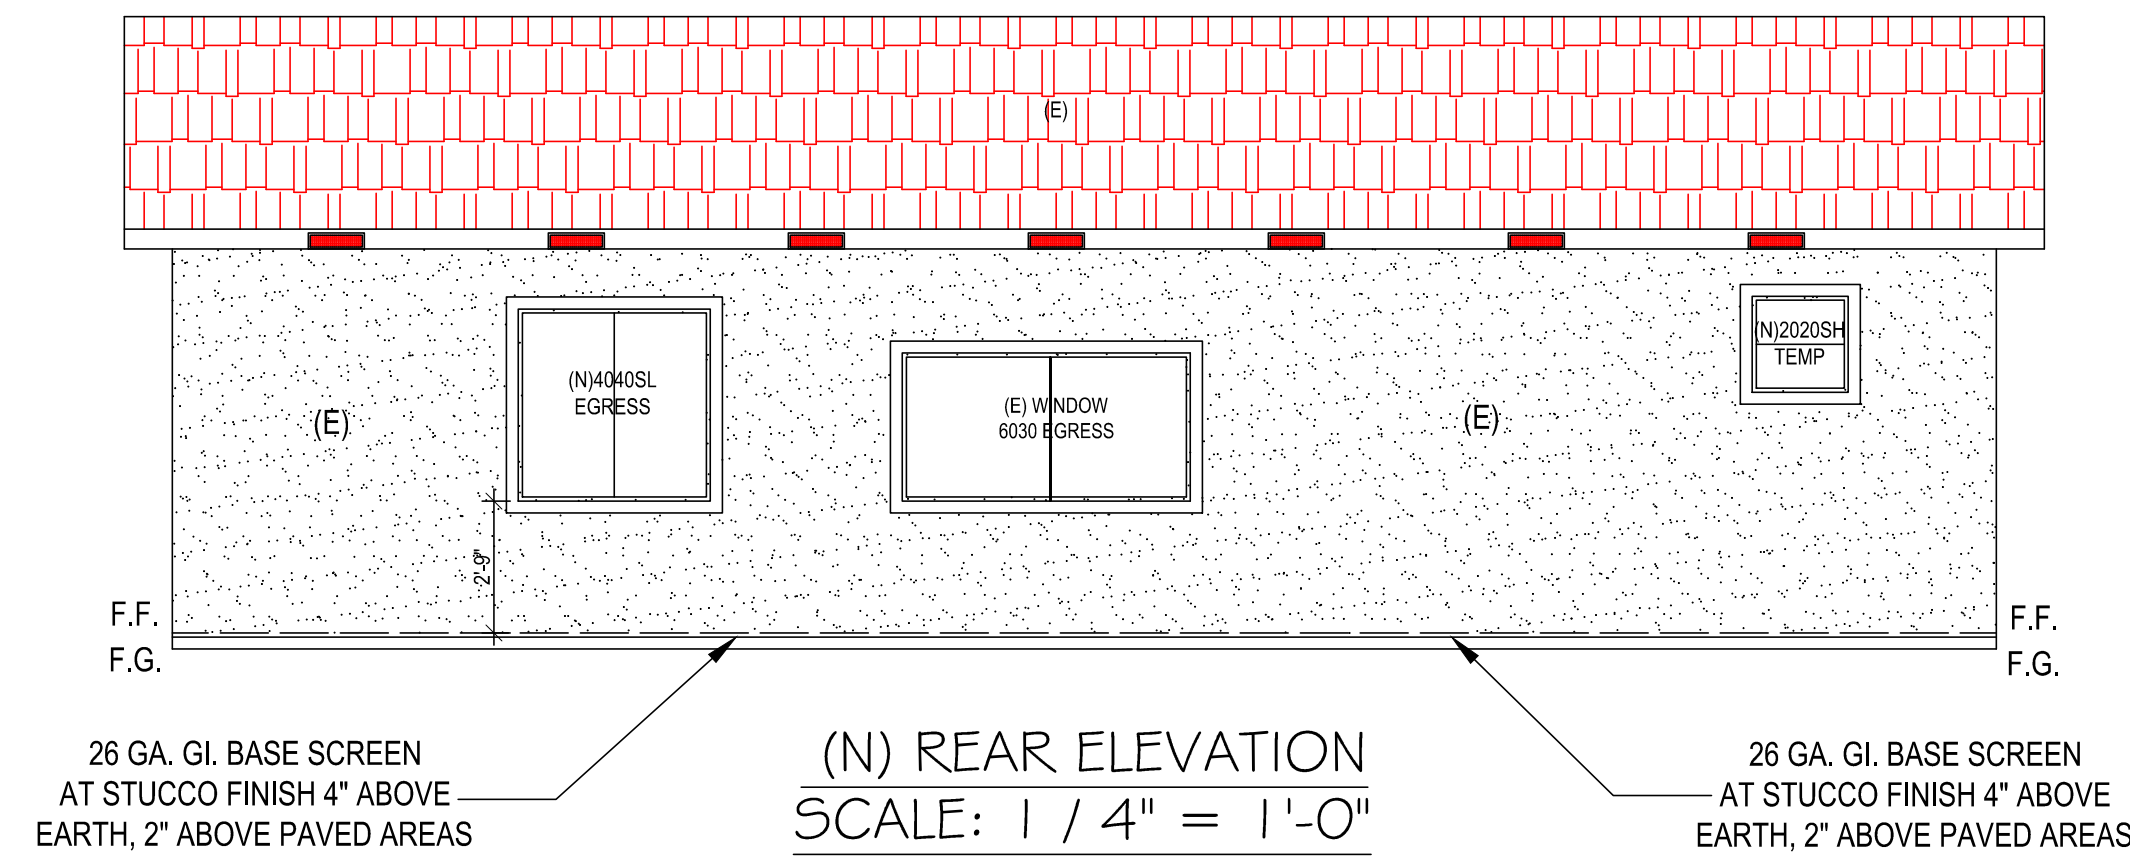
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ROOF VENTILATION:  
REQUIRED: 682 S.I.  
710 SF/150 = 4.73 SFx144= 682 S.I.  
PROPOSED: 636 S.I.  
14 EAVE VENTS: 14x 14x5 = 14x 44 = 616 S.I.  
2 GABLE VENT 2x 14x16 = 2x110 = 220 S.I.  
TOTAL = 836 S.I.



### Specifications

Brand: Construction Metals  
MFR #: EY1453/B  
Zone #: G408111453  
Country of Origin: United States  
Category: Attic Exhaust Ventilators

**Need Help?**  
Our customer service team is here for you.  
Frequently Asked Questions  
CONTACT US
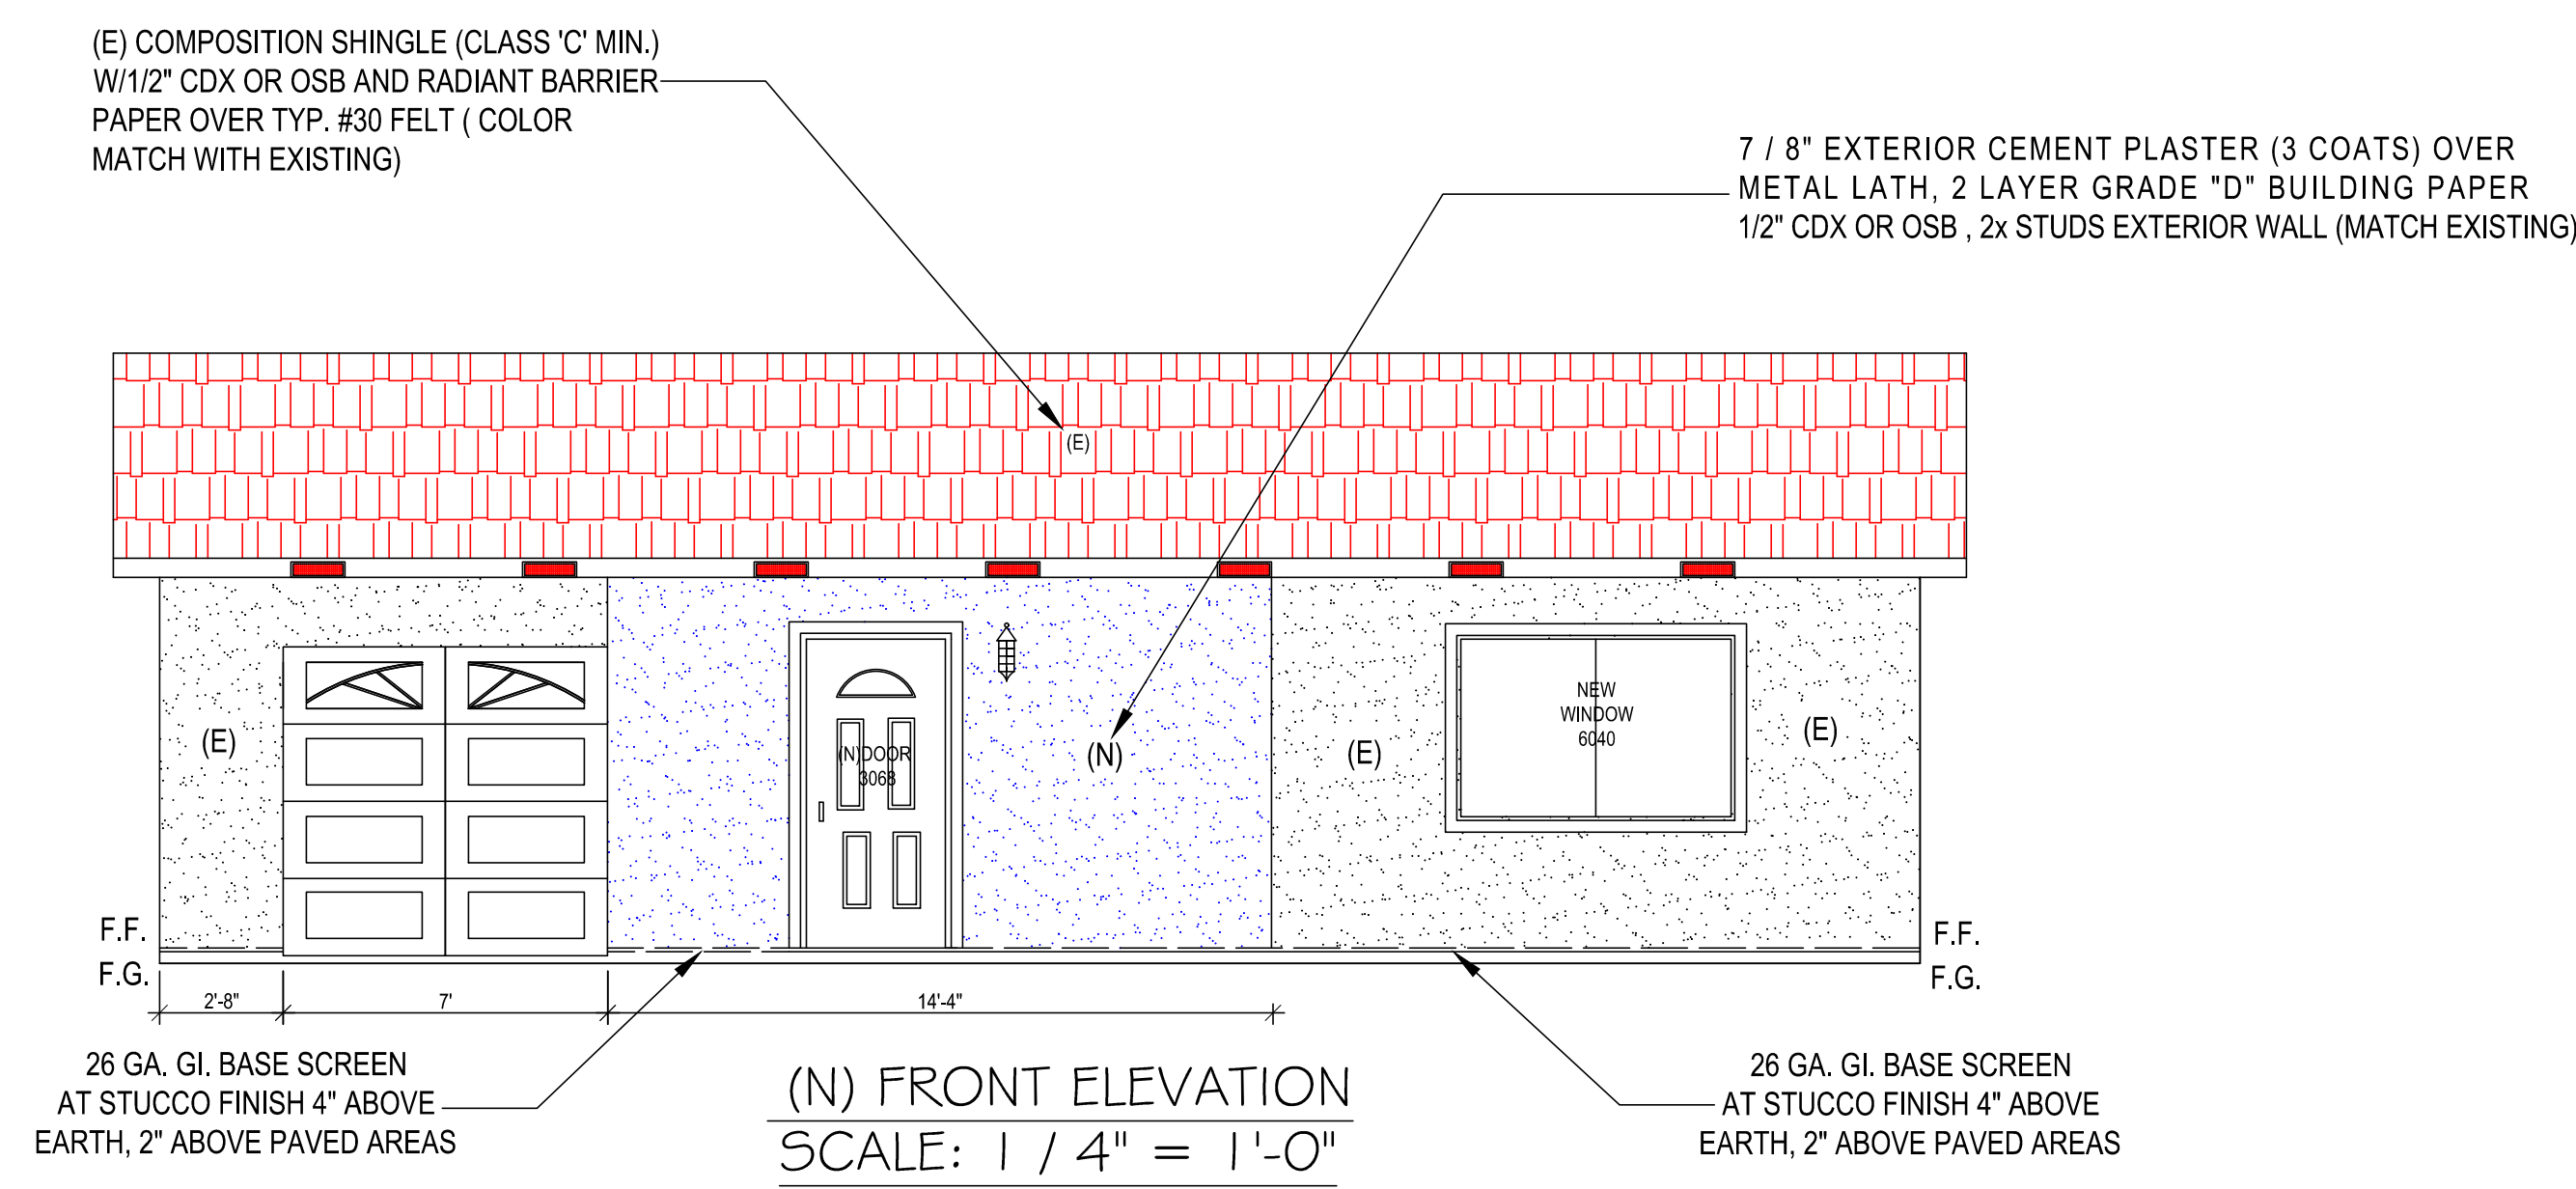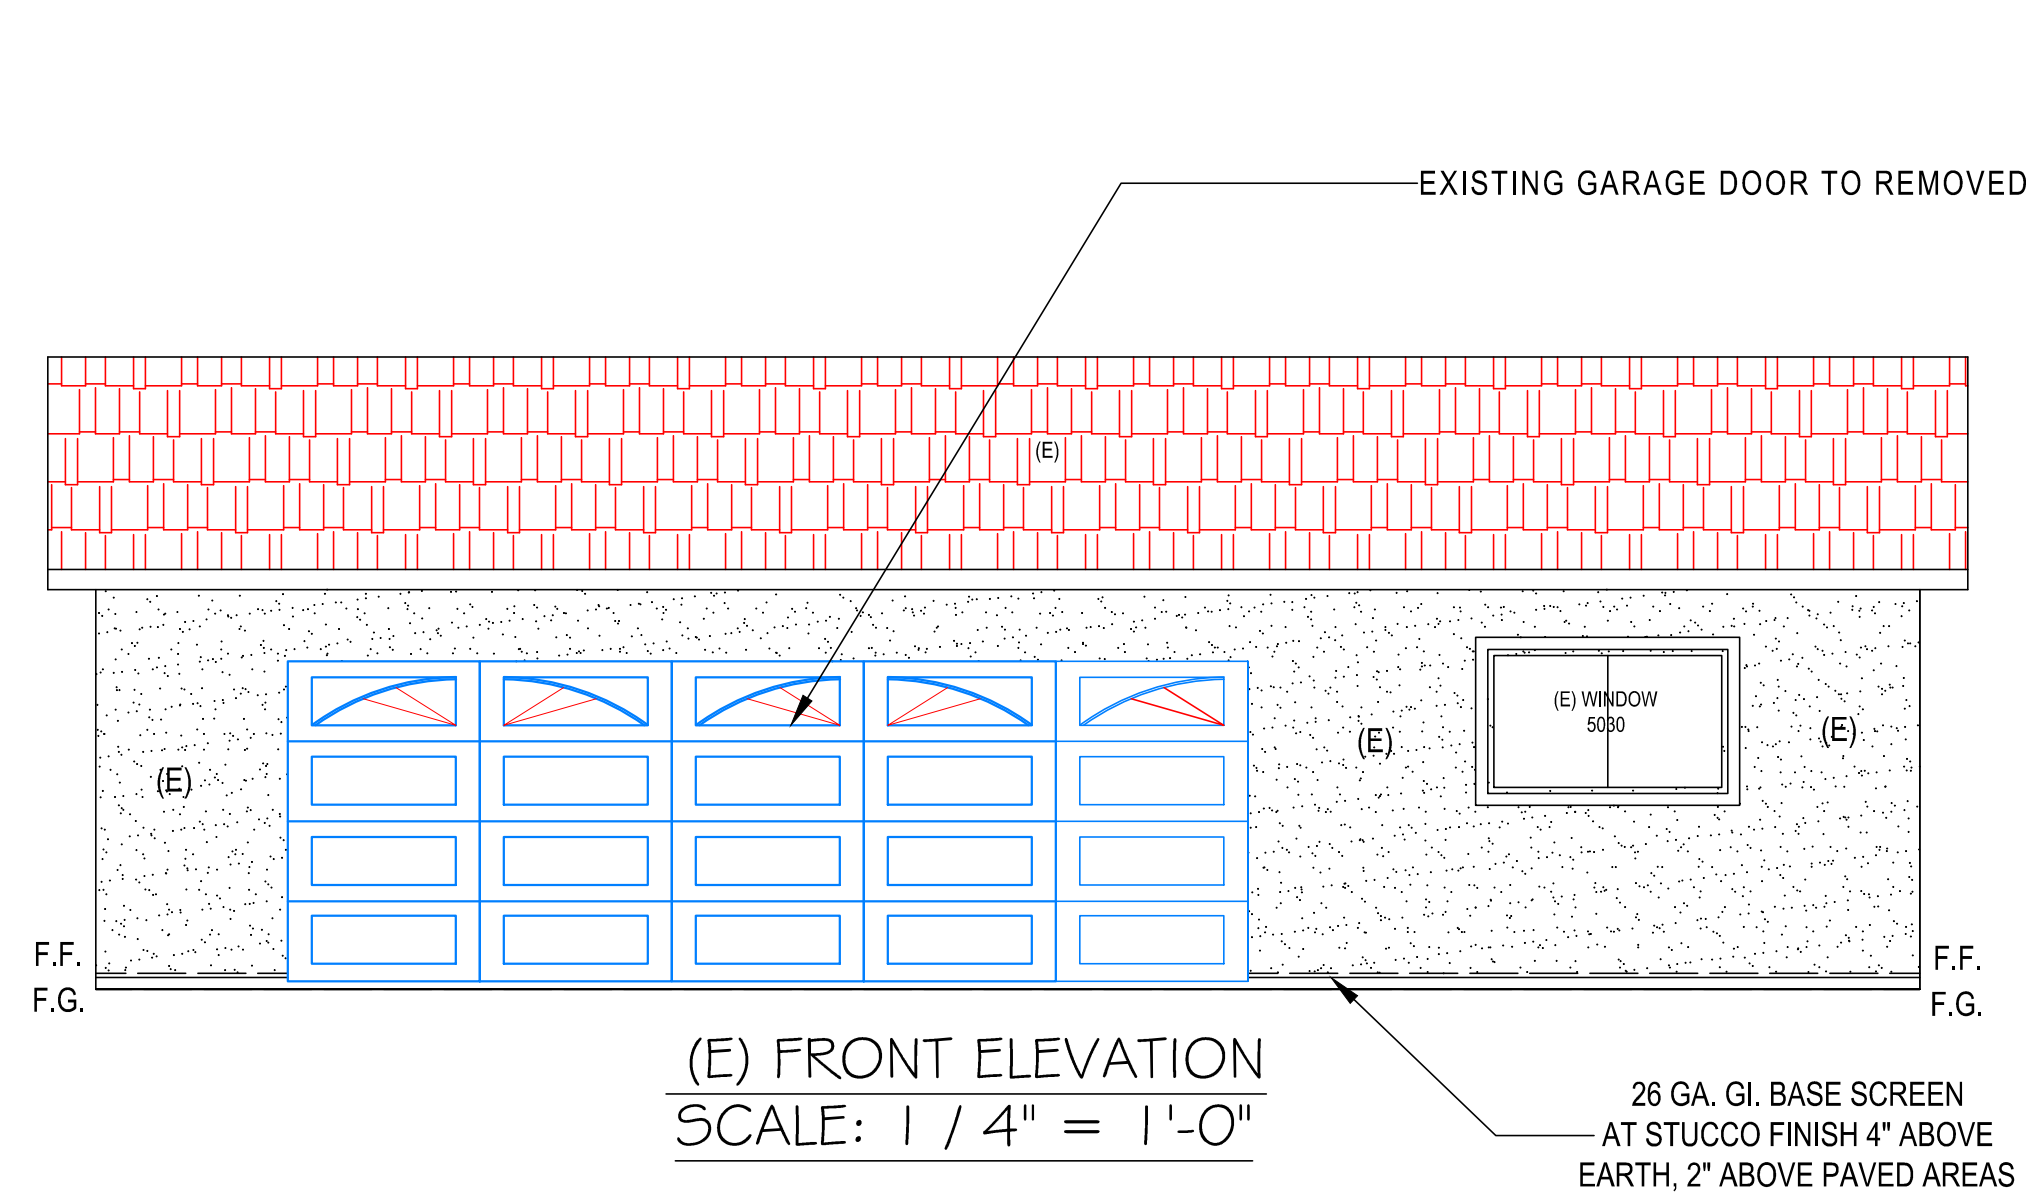
### Description

14 x 5 eave vent. Galvanized sheet metal frame 1/8 galvanized wire mesh 23 gauge, 44 sq in. Net free vent area. Flange and tabs for easy installation act as nailing flange to fasten to rafters or trusses.

### CONSTRUCTION METALS

#### 14x5 Eave Vent

Zone #: G408111453 MFR #: EY1453/B

### Product Details

Gable Louvers help provide attic ventilation to exhaust unwanted heat and moisture which can damage wood or roofing materials. A balanced ventilation system (50% intake ventilation combined with 50% exhaust ventilator) can also lower utility bills. Conforms to Federal Specification QQ-5775A, Type 1, Class 4 ASTM A-950, meets PHA codes, 28-Gauge galvanized steel, 1-pneuc construction with a 2-in. thick frame, 1/8 in. Galvanized wire mesh prevents entry from birds or large insects.

- Net free area: 110 sq. in.
- Durable polyester paint finish
- Rough opening: 14-1/4 in. x 18-1/4 in.
- Extra nailing flange for reroofed or siding applications
- 1/8 in. galvanized wire mesh to keep out birds and insects
- Screen included
- Return Policy
- California residents see Prop 65 WARNING

### Gable Louver Products

14 in. x 18 in. Rectangular White Galvanized Steel Built-in Screen Gable Louver Vent

★★★★★ 2m in. Screenshot & Screening

**TOMMY DRAFTING**  
9743 WHITE PINE WAY, ELK GROVE, CA 95624  
Email: helennguyen3689@gmail.com  
Tel: (916) 526-5881 & (408) 876-8402

Date: JULY 2023  
Scale: AS SHOWN  
Drawn: LUEN HONG NGUYEN  
Signed: *Thuy*

PROPOSAL ELEVATION  
236 ALDEN RD, HAYWARD, CA 94541


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BLD2023-02832  
Kevin Zhang

SHEET NO:  
**A-3**





Signed \_\_\_\_\_

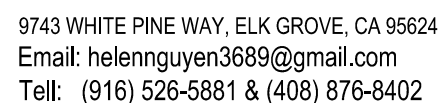SHEET NO

**REVIEWED**  
**ALAMEDA COUNTY PUBLIC WORKS AGENCY**  
**BUILDING INSPECTION DEPARTMENT**

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Kevin Zhang

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Registration Number: 225-P0166049288-000-000-00000000-0000	Registration Date/Time: 2023-10-24 15:00:17	HERS Provider: CaCERTS Inc
CA Building Energy Efficiency Standards - 2022 Residential Compliance	Report Version: 2022.0.000 Schema Version: rev 20220901	Report Generated: 2023-10-24 14:56:50

REVIEWED  
ALAMEDA COUNTY PUBLIC WORKS AGENCY  
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provisions of the adopted codes of any other law, rule, or

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CA Building Energy Efficiency Standards - 2022 Residential Compliance	Report Version: 2022.0.000 Schema Version: rev 20220901	Report Generated: 2023-10-24 14:56:50

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